



350 Elmwood Ave. • Buffalo, NY 14222

(P) 716.332.3134   (F) 716.332.3136

December 3, 2012

Mr. Mike Rogalski  
Ram-Tech Engineers  
2495 Main Street, Suite 435  
Buffalo, New York 14214


**Re: Pre-Renovation Asbestos Inspection Services**  
**Buffalo VA Steam Risers**  
**3495 Bailey Avenue**  
**Buffalo, New York 14215**

Dear Mr. Rogalski:

Enclosed please find a copy of the Pre-Renovation Asbestos Inspection report for the above-referenced property.

If after reviewing this report you have any questions, or if we can be of assistance in any other way, please do not hesitate to call. Thank you for the opportunity to be of service to Ram-Tech Engineers.

Sincerely,  
Sienna Environmental Technologies LLC

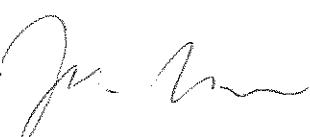  
John Pusztay  
Environmental Department Manager



## **Pre-Renovation Asbestos Inspection**

**Of**

**Buffalo VA Steam Risers  
3495 Bailey Avenue  
Buffalo, New York 14215**

**Prepared for:**

**Ram-Tech Engineers  
2495 Main Street, Suite 435  
Buffalo, New York 14214**

**Conditions as of:**

**November 21, 2012**



## **Summary Tabulation**

### **Pre-Renovation Asbestos Inspection**

1. Introduction
2. Methodology
3. Executive Summary
- 3A. Suspect Asbestos-containing Materials
- 3B. Asbestos-containing Materials
4. Inspection Notes

### **Appendices**

- A General Conditions of Inspection
- B Certifications and Licenses
- C Laboratory Reports and Chains of Custody
- D Asbestos Sample Floor Plans
- E Site Photographs



## Pre-Renovation Asbestos Inspection

### 1. Introduction

Sienna Environmental Technologies (Sienna) was retained by Ram-Tech Engineers to perform an investigation of Buffalo VA Steam Risers located at 3495 Bailey Avenue in Buffalo, New York for the presence of suspect asbestos-containing materials, prior to building renovation as indicated in progress drawings H100-H111 dated 10/24/12.

Sienna was charged with conducting the following tasks:

- Locating suspect asbestos containing materials
- Sampling of these materials to ascertain asbestos content
- Identifying the locations, quantities, friability and conditions of confirmed asbestos containing materials

Although the report is a comprehensive analysis of the asbestos inspection work performed, it would be helpful to review all applicable federal, state and local rules, laws and regulations regarding the handling and treatment of asbestos containing building materials (ACBM). The following is a list of suggested reading and information sources relating to asbestos:

- New York State Department of Labor Industrial Code Rule 56
- Occupational Safety and Health Administration
- Environmental Protection Agency Rule CFR 763.46 Asbestos Hazard Emergency Response Act

The report is generated for the exclusive use of client and is not designed to serve as a specification for abatement. Before requesting bids for abatement of materials identified in this report, the owner is strongly encouraged to contract with a consultant to provide this service.

### 2. Methodology

All work performed by Sienna Environmental Technologies was conducted in accordance with applicable regulations including New York State Department of Labor standards 12 NYCRR Part 56, National Emission Standards for Hazardous Air Pollutants (NESHAPS), and Occupational Safety and Health Administration regulations. All Sienna Environmental Technologies' personnel assigned to conduct inspections have completed the Environmental Protection Agency (EPA) required training and New York State Department of Labor Division of Safety and Health certification program.

Based on the homogeneous areas, samples of suspect materials were collected. Techniques used for sample collection were designed to minimize damage to suspected areas, reduce any potential for fiber release, and ensure the safety of the inspector and building occupants.

Samples were analyzed using Polarized Light Microscopy (PLM) in accordance with NYS DOH ELAP Item #198.1 or #198.6. For materials classified as non-friable organically bound materials (NOBs) that were analyzed as equal to or less than 1% asbestos by PLM, additional analysis was performed under Transmission Electron Microscopy (TEM) in accordance with NYS DOH ELAP Item #198.4. The results



of this analysis confirmed whether or not a suspect material actually contained asbestos. The confirmed materials are listed in **SECTION 3 Executive Summary**.

### 3. Executive Summary

The pre-renovation asbestos survey included identification, sampling, analysis and quantification of confirmed asbestos containing components at Buffalo VA Steam Risers, located at 3495 Bailey Avenue in Buffalo, New York. Copies of all laboratory analysis reports and chains of custody listing locations of sample collection are located in Appendix C.

#### 3A. Suspect Asbestos-containing Materials

The inspection was conducted on November 21, 2012 and revealed the following materials as requiring sampling and analysis (see Section 4 Inspection Notes):

##### Buffalo VA Steam Risers

HAN Number	Description
100A/B	Plaster Skim/Base coat
200A/B	
101A/B/C	Drywall Joint Tape/Joint Compound/ Drywall Board
205A/B/C	
102	4" Ceramic Tile Grout, Mastic, Thinset
201	2'x4' Dot and Fissure
202	2'x2' Dot and Fissure
203	1'x1' Dot and Fissure Pattern
204	2'x2' Textured Ceiling Tile
400	Mud Fittings
401	Transite Pipe
600	Fire Stop Caulk
601	Light Weight Cement
602	Encapsulant
603	Duct Sealant (brown)
604	Spray on Fire Proofing (grey)
605	Fire Door
606	6" Base Cove
607	Duct Sealant (grey)
608	4" Basecove



### 3B. Asbestos-containing Materials

Sampling and analysis of the suspect materials under Polarized Light Microscopy, and where necessary under Transmission Electron Microscopy, confirmed the following materials as asbestos containing building materials (See Appendix C for laboratory reports and chains of custody):

**Buffalo VA Steam Risers**

HAN Number	Description	Location *	Approximate Quantity	Friability	Condition
102	4" Ceramic Tile Grout, Mastic, Thinset (Note 4)	Room 3-7	240 SF	Friable	I
401	Transite Pipe (Note 4)	B-2 Stairwell, 1-1, 2-1, 3-1, 4-1, 5-5, 6-1, 7-1, 8-5, 9-2, 10-1	170 LF	Friable	I
605	Fire Door (Note 4)	Sub1, Sub Basement C-wing Hallway, Sub 5, Sub 7, B-1, B-2 Stairwell, B-3, 1-1, 1-4, 1-6, 1-7, 1-11, 2-1, 2-3, 2-7, 2-9, 2-11, 3-1, 3-6, 3-8, 4-1, 4-4, 4-6, 5-1, 5-2, 5-3, 5-5, 6-1, 6-2, 6-3, 6-5, 7-1, 7-2, 7-3, 7-5, 8-1, 8-3, 8-4, 8-5, 9-1, 9-2, 9-3, 9-5, 10-1, 10-2, 10-3 and 10-4	49 Fire Doors	Non-Friable	I
606	6" Basecove (Note 4)	B-4, B-5, 1-2, 1-3, 1-8, 1-9, 1-10, 2-4, 2-5, 2-8, 3-3, 3-7, 4-5, 5-6, 5-7, 6-4, 7-6, 9-4	611 SF	Non-Friable	I
608	4" Basecove (Note 4)	Rooms 1-5, 1-6, 1-12, 1-13, 2-10, 2-11, 5-4, 7-4 and 8-2	316 SF	Non-Friable	I

Condition Notes: I = Intact D = Damaged SD = Significantly Damaged

\*Refer to Appendix D for enumeration of spaces

### 4. Inspection Notes

Note 1: Flooring materials were not indicated to be disturbed by planned renovations, and were therefore not assessed during this inspection.

Note 2: Rooms 3-4 and 3-5 were inaccessible because they are sterile laboratory environments.

Note 3: No access to rooms 4-7 and 4-8.

Note 4: Material was not sampled and is assumed asbestos containing



## Appendix A General Conditions of Inspection

1. Sienna Environmental Technologies neither accepts nor implies any liability for the implementation of the recommendations found within this report.
2. This inspection was limited to areas accessible to the inspector. Sienna Environmental Technologies neither accepts nor implies any liability for ACM that may be present in other areas of the building.
3. The results of the laboratory analytical reports that may be contained herein are the product of the knowledge, experience and expertise of the laboratory retained to perform such services. Sienna Environmental Technologies neither accepts nor implies any liability for sample analysis reports compiled by others.
4. This report is based on the condition and contents present at the site on the day of the inspection. Sienna Environmental Technologies is not liable for materials, chemicals or other substances of concern that may have been removed from the site, cleaned or disposed of prior to the inspection date or subsequent to that date.
5. An inspection for asbestos relies heavily upon identification of homogeneous areas, with sampling and laboratory analysis then determined by the quantity of surfaces identified, generally accepted inspection protocols, regulatory requirements, and the inspector's judgment. Specific sample locations are determined with the objective of selecting representative samples. As with any type of sampling, the possibility of obtaining a false positive or false negative does exist, is inherent in the sampling process, and can at times result from the fact that asbestos fibers are not always uniformly distributed throughout suspect surfaces or materials. Although Sienna Environmental Technologies attempts to minimize the risk of a false positive or false negative result through a comprehensive inspection protocol, the possibility does exist, and could only be completely eliminated through testing and analysis of 100% of each suspect surface, which is not practical.



## Appendix B Certifications and Licenses

NEW YORK STATE DEPARTMENT OF LABOR  
DIVISION OF SAFETY AND HEALTH  
LICENSE AND CERTIFICATE UNIT  
STATE CAMPUS BUILDING 12  
ALBANY, NY 12240

ASBESTOS HANDLING LICENSE

Sienna Environmental Technologies LLC  
360 Elmwood Avenue  
Buffalo, NY 14222

FILE NUMBER: 00-1037  
LICENSE NUMBER: 29432  
LICENSE CLASS: RESTRICTED  
DATE OF ISSUE: 02/08/2012  
EXPIRATION DATE: 02/28/2013


Duly Authorized Representative: Susanne Kelley

This license has been issued in accordance with applicable provisions of Article 30 of the Labor Law of New York State and of the New York State Codes, Rules and Regulations (NYCRR Part 56). It is subject to suspension or revocation for a (1) serious violation of state, federal or local laws with regard to the conduct of an asbestos project, or (2) demonstrated lack of responsibility in the conduct of any job involving asbestos or asbestos material.

This license is valid only for the contractor named above and this license or a photocopy must be prominently displayed at the asbestos project worksite. This license verifies that all persons employed by the licensee on an asbestos project in New York State have been issued an Asbestos Certificate, appropriate for the type of work they perform, by the New York State Department of Labor.

Maureen A. Cox, Director  
FOR THE COMMISSIONER OF LABOR

STATE OF NEW YORK - DEPARTMENT OF LABOR  
ASBESTOS CERTIFICATE

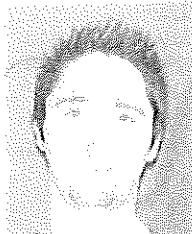

KRISTOPHER R DUNAWAY  
CLAS8(EXPIRES)  
CATEC(10/13) DJNSP(10/13)  
H PM (10/13)



CERT# 11-18263  
DMV# 408692118

MUST BE CARRIED ON ASBESTOS PROJECTS



IF FOUND RETURN TO:  
EYES HAZ  
HAIR BRO  
HGT 6' 07"  
NYSDSL - L&C UNIT  
ROOM 161A BUILDING 12  
STATE OFFICE CAMPUS  
ALBANY NY 12240

STATE OF NEW YORK - DEPARTMENT OF LABOR  
ASBESTOS CERTIFICATE



MARK A. BEVIER  
CLASS(EXPIRES)  
OATEC(04/13) D INSP(04/13)  
H-PM (04/13) II PD (04/14)

CERT# 11-10661  
DMV# 319717979  
MUST BE CARRIED ON ASBESTOS PROJECTS

NEW YORK STATE DEPARTMENT OF HEALTH  
WADSWORTH CENTER**COPY**Expires 12:01 AM April 01, 2013  
Issued April 1, 2012CERTIFICATE OF APPROVAL FOR LABORATORY SERVICE  
*Issued in accordance with and pursuant to section 502 Public Health Law of New York State*

DR. THOMAS MCKEE  
AMERISCI RICHMOND  
13635 GENITO RD  
MIDLTHIAN, VA 23112

NY Lab Id No: 10984

*Is hereby APPROVED as an Environmental Laboratory for the category  
ENVIRONMENTAL ANALYSES SOLID AND HAZARDOUS WASTE  
All approved subcategories and/or analyses are listed below:*

## Miscellaneous

Asbestos In Friable Material	EPA 600/M4/82/020
	Item 198.1 of Manual
Asbestos In Non-Friable Material-PLM	Item 198.6 of Manual (NOB by PLM)
Asbestos In Non-Friable Material-TEM	Item 198.4 of Manual


**COPY****COPY**

Serial No.: 46686

Property of the New York State Department of Health. Certificates are valid only at the address shown, must be conspicuously posted, and are printed on secure paper. Continued accreditation depends on successful ongoing participation in the Program. Consumers are urged to call (610) 483-5570 to verify the laboratory's accreditation status.



## **Appendix C Laboratory Reports and Chains of Custody**

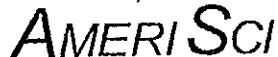 AMERI SCI

AmeriSci Richmond

13635 GENITO ROAD  
MIDLOTHIAN, VIRGINIA 23112  
TEL: (804) 763-1200 • FAX: (804) 763-1800

## PLM Bulk Asbestos Report

Sienna Environmental Technologies, LL Date Received 11/23/12 AmeriSci Job # 112111861  
Attn: Joseph Postore Date Examined 11/26/12 P.O. #  
350 Elmwood Ave ELAP # 10984 Page 1 of 9  
Buffalo, NY 14222 RE: SET 1941; Ram-Tech Engineers / Mike Rogalski; VA Hospital  
/ Bailey Ave

Client No. / HGA	Lab No.	Asbestos Present	Total % Asbestos
11/21-1941-100-A-1 1	112111861-01 Location: Skim; Sub-7	No	NAD (by NYS ELAP 198.1) by Donna M. Blackwell on 11/26/12
<b>Analyst Description:</b> White, Homogeneous, Non-Fibrous, Cementitious, Bulk Material <b>Asbestos Types:</b> <b>Other Material:</b> Non-fibrous 100 %			
11/21-1941-100-B-1 1			
<b>Analyst Description:</b> Gray, Homogeneous, Non-Fibrous, Cementitious, Bulk Material <b>Asbestos Types:</b> <b>Other Material:</b> Non-fibrous 100 %			
11/21-1941-100-A-2 1	112111861-02 Location: Base; Sub-7	No	NAD (by NYS ELAP 198.1) by Donna M. Blackwell on 11/26/12
<b>Analyst Description:</b> White, Homogeneous, Non-Fibrous, Cementitious, Bulk Material <b>Asbestos Types:</b> <b>Other Material:</b> Non-fibrous 100 %			
11/21-1941-100-B-2 1	112111861-03 Location: Skim; B-2	No	NAD (by NYS ELAP 198.1) by Donna M. Blackwell on 11/26/12
<b>Analyst Description:</b> Gray, Homogeneous, Non-Fibrous, Cementitious, Bulk Material <b>Asbestos Types:</b> <b>Other Material:</b> Non-fibrous 100 %			
11/21-1941-100-A-3 1	112111861-04 Location: Base; B-2	No	NAD (by NYS ELAP 198.1) by Donna M. Blackwell on 11/26/12
<b>Analyst Description:</b> Gray, Homogeneous, Non-Fibrous, Cementitious, Bulk Material <b>Asbestos Types:</b> <b>Other Material:</b> Non-fibrous 100 %			
11/21-1941-100-B-3 1	112111861-05 Location: Skim; 2-4	No	NAD (by NYS ELAP 198.1) by Donna M. Blackwell on 11/26/12
<b>Analyst Description:</b> White, Homogeneous, Non-Fibrous, Cementitious, Bulk Material <b>Asbestos Types:</b> <b>Other Material:</b> Non-fibrous 100 %			

See Reporting notes on last page

Client Name: Sienna Environmental Technologies, LLC

**PLM Bulk Asbestos Report**SET 1941; Ram-Tech Engineers / Mike Rogalski; VA Hospital /  
Bailey Ave

<b>Client No. / HGA</b>	<b>Lab No.</b>	<b>Asbestos Present</b>	<b>Total % Asbestos</b>
11/21-1941-100-B-3 1	112111861-06 Location: Base; 2-4	No	NAD (by NYS ELAP 198.1) by Donna M. Blackwell on 11/26/12
11/21-1941-100-A-4 1	112111861-07 Location: Skim; 2-8	No	NAD (by NYS ELAP 198.1) by Donna M. Blackwell on 11/26/12
11/21-1941-100-B-4 1	112111861-08 Location: Base; 2-8	No	NAD (by NYS ELAP 198.1) by Donna M. Blackwell on 11/26/12
11/21-1941-100-A-5 1	112111861-09 Location: Skim; 2-2	No	NAD (by NYS ELAP 198.1) by Donna M. Blackwell on 11/26/12
11/21-1941-100-B-5 1	112111861-10 Location: Base; 2-2	No	NAD (by NYS ELAP 198.1) by Donna M. Blackwell on 11/26/12
11/21-1941-200-A-1 2	112111861-11 Location: Skim; 4-4	No	NAD (by NYS ELAP 198.1) by Donna M. Blackwell on 11/26/12

Analyst Description: Gray, Homogeneous, Non-Fibrous, Cementitious, Bulk Material  
 Asbestos Types:  
 Other Material: Non-fibrous 100 %

Analyst Description: White, Homogeneous, Non-Fibrous, Cementitious, Bulk Material  
 Asbestos Types:  
 Other Material: Non-fibrous 100 %

Analyst Description: Gray, Homogeneous, Non-Fibrous, Cementitious, Bulk Material  
 Asbestos Types:  
 Other Material: Non-fibrous 100 %

Analyst Description: White, Homogeneous, Non-Fibrous, Cementitious, Bulk Material  
 Asbestos Types:  
 Other Material: Non-fibrous 100 %

Analyst Description: Gray, Homogeneous, Non-Fibrous, Cementitious, Bulk Material  
 Asbestos Types:  
 Other Material: Non-fibrous 100 %

Analyst Description: White, Homogeneous, Non-Fibrous, Cementitious, Bulk Material  
 Asbestos Types:  
 Other Material: Non-fibrous 100 %

Analyst Description: Gray, Homogeneous, Non-Fibrous, Cementitious, Bulk Material  
 Asbestos Types:  
 Other Material: Non-fibrous 100 %

Analyst Description: White, Homogeneous, Non-Fibrous, Cementitious, Bulk Material  
 Asbestos Types:  
 Other Material: Non-fibrous 100 %

Client Name: Sienna Environmental Technologies, LLC

**PLM Bulk Asbestos Report**SET 1941; Ram-Tech Engineers / Mike Rogalski; VA Hospital /  
Bailey Ave

<b>Client No. / HGA</b>	<b>Lab No.</b>	<b>Asbestos Present</b>	<b>Total % Asbestos</b>
11/21-1941-200-B-1 2	112111861-12 Location: Base; 4-4	No	NAD (by NYS ELAP 198.1) by Donna M. Blackwell on 11/26/12
<b>Analyst Description:</b> Gray, Homogeneous, Non-Fibrous, Cementitious, Bulk Material <b>Asbestos Types:</b> <b>Other Material:</b> Non-fibrous 100 %			
11/21-1941-200-A-2 2	112111861-13 Location: Skim; 5-5	No	NAD (by NYS ELAP 198.1) by Donna M. Blackwell on 11/26/12
<b>Analyst Description:</b> White, Homogeneous, Non-Fibrous, Cementitious, Bulk Material <b>Asbestos Types:</b> <b>Other Material:</b> Non-fibrous 100 %			
11/21-1941-200-B-2 2	112111861-14 Location: Base; 5-5	No	NAD (by NYS ELAP 198.1) by Donna M. Blackwell on 11/26/12
<b>Analyst Description:</b> Gray, Homogeneous, Non-Fibrous, Cementitious, Bulk Material <b>Asbestos Types:</b> <b>Other Material:</b> Non-fibrous 100 %			
11/21-1941-200-A-3 2	112111861-15 Location: Skim; 6-3	No	NAD (by NYS ELAP 198.1) by Donna M. Blackwell on 11/26/12
<b>Analyst Description:</b> White, Homogeneous, Non-Fibrous, Cementitious, Bulk Material <b>Asbestos Types:</b> <b>Other Material:</b> Non-fibrous 100 %			
11/21-1941-200-B-3 2	112111861-16 Location: Base; 6-3	No	NAD (by NYS ELAP 198.1) by Donna M. Blackwell on 11/26/12
<b>Analyst Description:</b> Gray, Homogeneous, Non-Fibrous, Cementitious, Bulk Material <b>Asbestos Types:</b> <b>Other Material:</b> Non-fibrous 100 %			
11/21-1941-200-A-4 2	112111861-17 Location: Skim; 10-2	No	NAD (by NYS ELAP 198.1) by Donna M. Blackwell on 11/26/12
<b>Analyst Description:</b> White, Homogeneous, Non-Fibrous, Cementitious, Bulk Material <b>Asbestos Types:</b> <b>Other Material:</b> Non-fibrous 100 %			

Client Name: Sienna Environmental Technologies, LLC

**PLM Bulk Asbestos Report**SET 1941; Ram-Tech Engineers / Mike Rogalski; VA Hospital /  
Bailey Ave

<b>Client No. / HGA</b>	<b>Lab No.</b>	<b>Asbestos Present</b>	<b>Total % Asbestos</b>
11/21-1941-200-B-4 2	112111861-18 Location: Base; 10-2	No	NAD (by NYS ELAP 198.1) by Donna M. Blackwell on 11/26/12
	<b>Analyst Description:</b> Gray, Homogeneous, Non-Fibrous, Cementitious, Bulk Material <b>Asbestos Types:</b> <b>Other Material:</b> Non-fibrous 100 %		
11/21-1941-201-1 3	112111861-19 Location: 2'x4' Ceiling Tile; B-2	No	NAD (by NYS ELAP 198.6) by Donna M. Blackwell on 11/26/12
	<b>Analyst Description:</b> Beige, Heterogeneous, Non-Fibrous, Bulk Material <b>Asbestos Types:</b> <b>Other Material:</b> Non-Asbestos/Inert 37.1 %		
11/21-1941-201-2 3	112111861-20 Location: 2'x4' Ceiling Tile; B-2	No	NAD (by NYS ELAP 198.6) by Donna M. Blackwell on 11/26/12
	<b>Analyst Description:</b> Beige, Heterogeneous, Non-Fibrous, Bulk Material <b>Asbestos Types:</b> <b>Other Material:</b> Non-Asbestos/Inert 35.4 %		
11/21-1941-202-1 4	112111861-21 Location: 2'x2' Ceiling Tile; B-4	No	NAD (by NYS ELAP 198.6) by Donna M. Blackwell on 11/26/12
	<b>Analyst Description:</b> Beige, Heterogeneous, Non-Fibrous, Bulk Material <b>Asbestos Types:</b> <b>Other Material:</b> Non-Asbestos/Inert 24.3 %		
11/21-1941-202-2 4	112111861-22 Location: 2'x2' Ceiling Tile; B-4	No	NAD (by NYS ELAP 198.6) by Donna M. Blackwell on 11/26/12
	<b>Analyst Description:</b> Beige, Heterogeneous, Non-Fibrous, Bulk Material <b>Asbestos Types:</b> <b>Other Material:</b> Non-Asbestos/Inert 26.5 %		
11/21-1941-203-1 5	112111861-23 Location: 1'x1' Ceiling Tile; 1-3	No	NAD (by NYS ELAP 198.6) by Donna M. Blackwell on 11/26/12
	<b>Analyst Description:</b> Beige, Heterogeneous, Non-Fibrous, Bulk Material <b>Asbestos Types:</b> <b>Other Material:</b> Non-Asbestos/Inert 59.7 %		

Client Name: Sienna Environmental Technologies, LLC

## PLM Bulk Asbestos Report

SET 1941; Ram-Tech Engineers / Mike Rogalski; VA Hospital /  
Bailey Ave

<b>Client No. / HGA</b>	<b>Lab No.</b>	<b>Asbestos Present</b>	<b>Total % Asbestos</b>
11/21-1941-203-2 5	112111861-24 Location: 1'x1' Ceiling Tile; 1-3	No	NAD (by NYS ELAP 198.6) by Donna M. Blackwell on 11/26/12
		Analyst Description: Beige, Heterogeneous, Non-Fibrous, Bulk Material Asbestos Types: Other Material: Non-Asbestos/Inert 64.7 %	
11/21-1941-204-1 6	112111861-25 Location: 2'x2' Ceiling Tile; 1-10	No	NAD (by NYS ELAP 198.6) by Donna M. Blackwell on 11/26/12
		Analyst Description: Beige, Heterogeneous, Non-Fibrous, Bulk Material Asbestos Types: Other Material: Non-Asbestos/Inert 38.5 %	
11/21-1941-204-2 6	112111861-26 Location: 2'x2' Ceiling Tile; 1-10	No	NAD (by NYS ELAP 198.6) by Donna M. Blackwell on 11/26/12
		Analyst Description: Beige, Heterogeneous, Non-Fibrous, Bulk Material Asbestos Types: Other Material: Non-Asbestos/Inert 44.9 %	
11/21-1941-101-A-1 7	112111861-27 Location: Joint Tape; B-2	No	NAD (by NYS ELAP 198.1) by Donna M. Blackwell on 11/26/12
		Analyst Description: White, Heterogeneous, Fibrous, Bulk Material Asbestos Types: Other Material: Cellulose 100 %	
11/21-1941-101-B-1 7	112111861-28 Location: Joint Compound; B-2	No	NAD (by NYS ELAP 198.1) by Donna M. Blackwell on 11/26/12
		Analyst Description: White, Homogeneous, Non-Fibrous, Bulk Material Asbestos Types: Other Material: Non-fibrous 100 %	
11/21-1941-101-C-1 7	112111861-29 Location: Drywall; B-2	No	NAD (by NYS ELAP 198.1) by Donna M. Blackwell on 11/26/12
		Analyst Description: Brown/Off-White, Heterogeneous, Fibrous, Bulk Material Asbestos Types: Other Material: Cellulose 15 %, Fibrous glass 3 %, Non-fibrous 82 %	

Client Name: Sienna Environmental Technologies, LLC

**PLM Bulk Asbestos Report**SET 1941; Ram-Tech Engineers / Mike Rogalski; VA Hospital /  
Bailey Ave

<b>Client No. / HGA</b>	<b>Lab No.</b>	<b>Asbestos Present</b>	<b>Total % Asbestos</b>
11/21-1941-205-A-1 8	112111861-30 Location: Joint Tape; 5-4	No	NAD (by NYS ELAP 198.1) by Donna M. Blackwell on 11/26/12
	<b>Analyst Description:</b> White, Heterogeneous, Fibrous, Bulk Material <b>Asbestos Types:</b> <b>Other Material:</b> Non-fibrous 100 %		
11/21-1941-205-B-1 8	112111861-31 Location: Joint Compound; 5-4	No	NAD (by NYS ELAP 198.1) by Donna M. Blackwell on 11/26/12
	<b>Analyst Description:</b> White, Heterogeneous, Fibrous, Bulk Material <b>Asbestos Types:</b> <b>Other Material:</b> Non-fibrous 100 %		
11/21-1941-205-C-1 8	112111861-32 Location: Drywall; 5-4	No	NAD (by NYS ELAP 198.1) by Donna M. Blackwell on 11/26/12
	<b>Analyst Description:</b> Brown/Off-White, Heterogeneous, Fibrous, Bulk Material <b>Asbestos Types:</b> <b>Other Material:</b> Cellulose 13 %, Fibrous glass 2 %, Non-fibrous 85 %		
11/21-1941-400-1 9	112111861-33 Location: Mud Fittings; Sub-4	No	NAD (by NYS ELAP 198.1) by Donna M. Blackwell on 11/26/12
	<b>Analyst Description:</b> Gray, Heterogeneous, Fibrous, Bulk Material <b>Asbestos Types:</b> <b>Other Material:</b> Fibrous glass 40 %, Non-fibrous 60 %		
11/21-1941-400-2 9	112111861-34.1 Location: Mud Fittings; Sub-4	No	NAD (by NYS ELAP 198.1) by Donna M. Blackwell on 11/26/12
	<b>Analyst Description:</b> Gray, Homogeneous, Fibrous, Mud <b>Asbestos Types:</b> <b>Other Material:</b> Fibrous glass 40 %, Non-fibrous 60 %		
11/21-1941-400-2 9	112111861-34.2 Location: Mud Fittings; Sub-4	No	NAD (by NYS ELAP 198.1) by Donna M. Blackwell on 11/26/12
	<b>Analyst Description:</b> Gray-White, Homogeneous, Non-Fibrous, Wrap <b>Asbestos Types:</b> <b>Other Material:</b> Cellulose 5 %, Fibrous glass 50 %, Non-fibrous 45 %		

Client Name: Sienna Environmental Technologies, LLC

**PLM Bulk Asbestos Report**SET 1941; Ram-Tech Engineers / Mike Rogalski; VA Hospital /  
Bailey Ave

<b>Client No. / HGA</b>	<b>Lab No.</b>	<b>Asbestos Present</b>	<b>Total % Asbestos</b>
11/21-1941-600-1 10	112111861-35 Location: Fire Stop Caulk; Sub-5	No	NAD (by NYS ELAP 198.6) by Donna M. Blackwell on 11/26/12
	<b>Analyst Description:</b> Red, Heterogeneous, Non-Fibrous, Bulk Material <b>Asbestos Types:</b> <b>Other Material:</b> Non-Asbestos/Inert 17.5 %		
11/21-1941-600-2 10	112111861-36 Location: Fire Stop Caulk; Sub-4	No	NAD (by NYS ELAP 198.6) by Donna M. Blackwell on 11/26/12
	<b>Analyst Description:</b> Red, Heterogeneous, Non-Fibrous, Bulk Material <b>Asbestos Types:</b> <b>Other Material:</b> Non-Asbestos/Inert 18.9 %		
11/21-1941-601-1 11	112111861-37 Location: Light Weight Cement; Sub-4	No	NAD (by NYS ELAP 198.1) by Donna M. Blackwell on 11/26/12
	<b>Analyst Description:</b> Gray, Homogeneous, Non-Fibrous, Cementitious, Bulk Material <b>Asbestos Types:</b> <b>Other Material:</b> Non-fibrous 100 %		
11/21-1941-601-2 11	112111861-38 Location: Light Weight Cement; Sub-5	No	NAD (by NYS ELAP 198.1) by Donna M. Blackwell on 11/26/12
	<b>Analyst Description:</b> Gray, Homogeneous, Non-Fibrous, Cementitious, Bulk Material <b>Asbestos Types:</b> <b>Other Material:</b> Non-fibrous 100 %		
11/21-1941-602-1 12	112111861-39 Location: Encapsulant; Sub-8	No	NAD (by NYS ELAP 198.6) by Donna M. Blackwell on 11/26/12
	<b>Analyst Description:</b> White, Heterogeneous, Non-Fibrous, Bulk Material <b>Asbestos Types:</b> <b>Other Material:</b> Non-Asbestos/Inert 44.5 %		
11/21-1941-602-2 12	112111861-40 Location: Encapsulant; Sub-7	No	NAD (by NYS ELAP 198.6) by Donna M. Blackwell on 11/26/12
	<b>Analyst Description:</b> White, Heterogeneous, Non-Fibrous, Bulk Material <b>Asbestos Types:</b> <b>Other Material:</b> Non-Asbestos/Inert 50.2 %		

Client Name: Sienna Environmental Technologies, LLC

## PLM Bulk Asbestos Report

SET 1941; Ram-Tech Engineers / Mike Rogalski; VA Hospital /  
Bailey Ave

<b>Client No. / HGA</b>	<b>Lab No.</b>	<b>Asbestos Present</b>	<b>Total % Asbestos</b>
11/21-1941-603-1 13	112111861-41 Location: Duct Sealant - Brown; Sub-2	No	NAD (by NYS ELAP 198.6) by Donna M. Blackwell on 11/26/12
<b>Analyst Description:</b> Tan, Heterogeneous, Non-Fibrous, Bulk Material <b>Asbestos Types:</b> <b>Other Material:</b> Non-Asbestos/Inert 36.6 %			
11/21-1941-603-2 13	112111861-42 Location: Duct Sealant - Brown; Sub-2	No	NAD (by NYS ELAP 198.6) by Donna M. Blackwell on 11/26/12
<b>Analyst Description:</b> Tan, Heterogeneous, Non-Fibrous, Bulk Material <b>Asbestos Types:</b> <b>Other Material:</b> Non-Asbestos/Inert 34.6 %			
11/21-1941-604-1 14	112111861-43 Location: Spray On Fireproofing; Sub-1	No	NAD (by NYS ELAP 198.1) by Donna M. Blackwell on 11/26/12
<b>Analyst Description:</b> Gray, Heterogeneous, Fibrous, Bulk Material <b>Asbestos Types:</b> <b>Other Material:</b> Fibrous glass 95 %, Non-fibrous 5 %			
11/21-1941-604-2 14	112111861-44 Location: Spray On Fireproofing; Sub-1	No	NAD (by NYS ELAP 198.1) by Donna M. Blackwell on 11/26/12
<b>Analyst Description:</b> Gray, Heterogeneous, Fibrous, Bulk Material <b>Asbestos Types:</b> <b>Other Material:</b> Fibrous glass 98 %, Non-fibrous 2 %			
11/21-1941-604-3 14	112111861-45 Location: Spray On Fireproofing; Sub-1	No	NAD (by NYS ELAP 198.1) by Donna M. Blackwell on 11/26/12
<b>Analyst Description:</b> Gray, Heterogeneous, Fibrous, Bulk Material <b>Asbestos Types:</b> <b>Other Material:</b> Fibrous glass 95 %, Non-fibrous 5 %			
11/21-1941-607-1 15	112111861-46 Location: Duct Sealant - Grey; B-5	No	NAD (by NYS ELAP 198.6) by Donna M. Blackwell on 11/26/12
<b>Analyst Description:</b> Gray, Heterogeneous, Non-Fibrous, Bulk Material <b>Asbestos Types:</b> <b>Other Material:</b> Non-Asbestos/Inert 4.5 %			

Client Name: Sienna Environmental Technologies, LLC

## PLM Bulk Asbestos Report

SET 1941; Ram-Tech Engineers / Mike Rogalski; VA Hospital /  
Bailey Ave

Client No. / HGA	Lab No.	Asbestos Present	Total % Asbestos
11/21-1941-607-2 15	112111861-47 Location: Duct Sealant - Grey; B-5	No	NAD (by NYS ELAP 198.6) by Donna M. Blackwell on 11/26/12
<b>Analyst Description:</b> Gray, Heterogeneous, Non-Fibrous, Bulk Material <b>Asbestos Types:</b> <b>Other Material:</b> Non-Asbestos/Inert 4.2 %			

**Reporting Notes:**

Analyzed by: Donna M. Blackwell *Donna M. Blackwell* 11/26/12  
 \*NAD = no asbestos detected, Detection Limit <1%, Reporting Limits: CVES = 1%, 400 Pt Ct = 0.25%, 1000 Pt Ct = 0.1%; "Present" or NVA = "No Visible Asbestos" are observations made during a qualitative analysis; NA = not analyzed; NA/PS = not analyzed / positive stop; PLM Bulk Asbestos Analysis by EPA 600/M4-82-020 per 40 CFR 763 (NVLAP Lab Code 101904-0) and ELAP PLM Analysis Protocol 198.1 for New York friable samples (198.6 for NOB samples)(NYSDOH ELAP Lab # 10984); CA ELAP Lab # 2508; Note: PLM is not consistently reliable in detecting asbestos in floor coverings and similar NOB materials. NAD or Trace results by PLM are inconclusive, TEM is currently the only method that can be used to determine if this material can be considered or treated as non-asbestos-containing in New York State (also see EPA Advisory for floor tile, FR 59, 146, 38970, 8/1/94). NIST Accreditation requirements mandate that this report must not be reproduced except in full without the approval of the laboratory. This PLM report relates ONLY to the items tested.

Reviewed By: \_\_\_\_\_

**Table I**  
**Summary of Bulk Asbestos Analysis Results**  
 SET 1941; Ram-Tech Engineers / Mike Rogalski; VA Hospital / Bailey Ave

AmeriSci Sample #	Client Sample#	HG Area	Sample Weight (gram)	Heat Sensitive Organic %	Acid Soluble Inorganic %	Insoluble Non-Asbestos Inorganic %	** Asbestos % by PLMIDS	** Asbestos % by TEM
01	11/21-1941-100-A-1	1	—	—	—	—	NAD	NA
Location: Skim; Sub-7	11/21-1941-100-B-1	1	—	—	—	—	NAD	NA
02	11/21-1941-100-A-2	1	—	—	—	—	NAD	NA
Location: Base; Sub-7	11/21-1941-100-A-2	1	—	—	—	—	NAD	NA
03	11/21-1941-100-B-2	1	—	—	—	—	NAD	NA
Location: Skim; B-2	11/21-1941-100-B-2	1	—	—	—	—	NAD	NA
04	11/21-1941-100-B-3	1	—	—	—	—	NAD	NA
Location: Base; B-2	11/21-1941-100-B-3	1	—	—	—	—	NAD	NA
05	11/21-1941-100-A-3	1	—	—	—	—	NAD	NA
Location: Skim; 2-4	11/21-1941-100-A-3	1	—	—	—	—	NAD	NA
06	11/21-1941-100-B-3	1	—	—	—	—	NAD	NA
Location: Base; 2-4	11/21-1941-100-B-3	1	—	—	—	—	NAD	NA
07	11/21-1941-100-A-4	1	—	—	—	—	NAD	NA
Location: Skim; 2-8	11/21-1941-100-A-4	1	—	—	—	—	NAD	NA
08	11/21-1941-100-B-4	1	—	—	—	—	NAD	NA
Location: Base; 2-8	11/21-1941-100-B-4	1	—	—	—	—	NAD	NA
09	11/21-1941-100-A-5	1	—	—	—	—	NAD	NA
Location: Skim; 2-2	11/21-1941-100-A-5	1	—	—	—	—	NAD	NA
10	11/21-1941-100-B-5	1	—	—	—	—	NAD	NA
Location: Base; 2-2	11/21-1941-100-B-5	1	—	—	—	—	NAD	NA
11	11/21-1941-200-A-1	2	—	—	—	—	NAD	NA
Location: Skim; 4-4	11/21-1941-200-A-1	2	—	—	—	—	NAD	NA
12	11/21-1941-200-B-1	2	—	—	—	—	NAD	NA
Location: Base; 4-4	11/21-1941-200-B-1	2	—	—	—	—	NAD	NA
13	11/21-1941-200-A-2	2	—	—	—	—	NAD	NA
Location: Skim; 5-5	11/21-1941-200-A-2	2	—	—	—	—	NAD	NA
14	11/21-1941-200-B-2	2	—	—	—	—	NAD	NA
Location: Base; 5-5	11/21-1941-200-B-2	2	—	—	—	—	NAD	NA
15	11/21-1941-200-A-3	2	—	—	—	—	NAD	NA
Location: Skim; 6-3	11/21-1941-200-A-3	2	—	—	—	—	NAD	NA
16	11/21-1941-200-B-3	2	—	—	—	—	NAD	NA
Location: Base; 6-3	11/21-1941-200-B-3	2	—	—	—	—	NAD	NA

**Table I**  
**Summary of Bulk Asbestos Analysis Results**  
SET 1941; Ram-Tech Engineers / Mike Rogalski; VA Hospital / Bailey Ave

AmeriSci Sample #	Client Sample#	HG Area	Sample Weight (gram)	Heat Sensitive Organic %	Acid Soluble Inorganic %	Insoluble Non-Asbestos Inorganic %	** Asbestos % by PLM/IDS	*** Asbestos % by TEM
17	11/21-1941-200-A-4	2	—	—	—	—	NAD	NA
18	Skim; 10-2 11/21-1941-200-B-4	2	—	—	—	—	NAD	NAD
19	Location: Base; 10-2 11/21-1941-201-1	3	0.351	14.0	48.9	37.1	NAD	NAD
20	Location: 2x4' Ceiling Tile; B-2 11/21-1941-201-2	3	0.398	13.5	51.1	35.4	NAD	NAD
21	Location: 2x4' Ceiling Tile; B-2 11/21-1941-202-1	4	0.597	15.9	59.9	24.3	NAD	NAD
22	Location: 2x2' Ceiling Tile; B-4 11/21-1941-202-2	4	0.322	14.5	59.1	26.5	NAD	NAD
23	Location: 2x2' Ceiling Tile; B-4 11/21-1941-203-1	5	0.388	14.3	26.0	59.7	NAD	NAD
24	Location: 1x1' Ceiling Tile; 1-3 11/21-1941-203-2	5	0.504	16.0	19.3	64.7	NAD	NAD
25	Location: 1x1' Ceiling Tile; 1-3 11/21-1941-204-1	6	0.359	23.5	38.0	38.5	NAD	NAD
26	Location: 2x2' Ceiling Tile; 1-10 11/21-1941-204-2	6	0.378	22.2	32.9	44.9	NAD	NAD
27	Location: 2x2' Ceiling Tile; 1-10 11/21-1941-101-A-1	7	—	—	—	—	NAD	NA
28	Location: Joint Tape; B-2 11/21-1941-101-B-1	7	—	—	—	—	NAD	NA
29	Location: Joint Compound; B-2 11/21-1941-101-C-1	7	—	—	—	—	NAD	NA
30	Location: Drywall; B-2 11/21-1941-205-A-1	8	—	—	—	—	NAD	NA
31	Location: Joint Tape; 5-4 11/21-1941-205-B-1	8	—	—	—	—	NAD	NA
32	Location: Joint Compound; 5-4 11/21-1941-205-C-1	8	—	—	—	—	NAD	NA

**Table I**  
**Summary of Bulk Asbestos Analysis Results**  
SET 1941; Ram-Tech Engineers / Mike Rogalski; VA Hospital / Bailey Ave

AmeriSci Sample #	Client Sample#	HG Area	Sample Weight (gram)	Heat Sensitive Organic %	Acid Soluble Inorganic %	Insoluble Non-Asbestos Inorganic %	** Asbestos % by PLM/IDS	** Asbestos % by TEM
33	11/21-1941-400-1	9	—	—	—	—	NAD	NA
Location: Mud Fittings; Sub-4	11/21-1941-400-2	9	—	—	—	—	NAD	NA
34.1	Location: Mud Fittings; Sub-4	9	—	—	—	—	NAD	NA
34.2	Location: Mud Fittings; Sub-4	11/21-1941-400-2	9	—	—	—	NAD	NAD
35	Location: Mud Fittings; Sub-4	11/21-1941-600-1	10	0.572	39.7	42.7	17.5	NAD
36	Location: Fire Stop Caulk; Sub-5	11/21-1941-600-2	10	0.747	40.6	40.5	18.9	NAD
37	Location: Fire Stop Caulk; Sub-4	11/21-1941-601-1	11	—	—	—	NAD	NA
38	Location: Light Weight Cement; Sub-4	11/21-1941-601-2	11	—	—	—	NAD	NA
39	Location: Light Weight Cement; Sub-5	11/21-1941-602-1	12	0.461	43.4	12.1	44.5	NAD
40	Location: Encapsulant; Sub-8	11/21-1941-602-2	12	0.487	42.5	7.3	50.2	NAD
41	Location: Encapsulant; Sub-7	11/21-1941-603-1	13	0.569	61.2	2.2	36.5	NAD
42	Location: Duct Sealant - Brown; Sub-2	11/21-1941-603-2	13	0.460	61.4	4.0	34.5	NAD
43	Location: Duct Sealant - Brown; Sub-2	11/21-1941-604-1	14	—	—	—	—	NAD
44	Location: Spray On Fireproofing; Sub-1	11/21-1941-604-2	14	—	—	—	—	NAD
45	Location: Spray On Fireproofing; Sub-1	11/21-1941-604-3	14	—	—	—	—	NAD
46	Location: Spray On Fireproofing; Sub-1	11/21-1941-607-1	15	0.341	34.6	61.0	4.5	NAD
47	Location: Duct Sealant - Grey; B-5	11/21-1941-607-2	15	0.330	34.2	61.6	4.2	NAD
	Location: Duct Sealant - Grey; B-5							

**Table I**  
**Summary of Bulk Asbestos Analysis Results**  
SET 1941; Ram-Tech Engineers / Mike Rogalski; VA Hospital / Bailey Ave

AmeriSci Sample #	Client Sample#	HG Area	Sample Weight (gram)	Heat Sensitive Organic %	Acid Soluble Inorganic %	Insoluble Non-Asbestos Inorganic %	** Asbestos % by PLM/DS	** Asbestos % by TEM

Reviewed by: \_\_\_\_\_ Date Reviewed: \_\_\_\_\_

Analyzed By: Beverly A. Schrage

Date Analyzed: 11/26/2012

Semi-Quantitative Analysis: NAD = no asbestos detected; NA/PS = not analyzed due to positive stop; Trace = <1%;  
PLM analysis by EPA 600/M4-82-020 per 40 CFR 763 (NVLAP Lab Code 101904-0) or NY ELAP 198.1 for New York friable samples (198.6 for NOB samples); (NY ELAP Lab # 10984);  
TEM analysis by EPA 600/R-93/116 (not covered by NVLAP Bulk accreditation); or NY ELAP 198.4 for New York NOB samples (NY ELAP Lab # 10984);

\*\* Warning Notes: Consider PLM fiber diameter limitation, only TEM will resolve fibers <0.25 micrometers in diameter. TEM bulk analysis is representative of the fine grained matrix material and may not be representative of non-uniformly dispersed debris, soils or other heterogeneous materials for which a combination PLM/TEM evaluation is recommended; Quantitation for beginning weights of <0.1 grams should be considered as qualitative only.

Fax/Email Report to: \_\_\_\_\_

Client/Contact:	Ram-Tech Engineers /Mike Rogalski	Turn around (circle)
Building/Location:	V.A Hospital / Bailey Ave	RUSH      48 Hour
Job #:	SET 1941 Total # Samples: 47	24 Hour      72 Hour

 PLM     TEM     AAS     OTHER

Sample #				Description of Sample	Location of Sample	Notes
Date	Job	HAN	ID#			
11/21	1941	100	A-1	Skim	Sub 7	
			B-1	Base	↓	
			A-2	Skim	B-2	
			B-2	Base	↓	
			A-3	Skim	2-4	
			B-3	Base	↓	
			A-4	Skim	2-8	
			B-4	Base	↓	
			A-5	Skim	2-2	
		↓	B-5	Base	↓	
	200		A-1	Skim	4-4	x
			B-1	Base	↓	
			A-2	Skim	5-5	
			B-2	Base	↓	
↓	↓	↓	A-3	Skim	6-3	

Notes:  
 Yes     No

Negative PLM to TEM per ELAP protocols

Positive stop by HAN

Layered analysis is expected - Sample HAN-ID #

Sampled By: MKL

Date: 11/21/12

Relinquished By: KRD

Date: 11/21/12

Received By: \_\_\_\_\_

Date: \_\_\_\_\_

Fax/Email Report to: \_\_\_\_\_

Client/Contact:	Ram-Tech Engineers / Mike Rosalski	Turn around (circle)
Building/Location:	V.A Hospital / Bailey Ave.	RUSH      48 Hour
Job #:	SET 1941 Total # Samples: 47	24 Hour <input checked="" type="radio"/> 72 Hour <input type="radio"/>

Sample #				Description of Sample	Location of Sample	Notes
Date	Job	HAN	ID#			
11/21	1941	200	B-3	Base	b-3	
			A-4	Skim	10-2	
		↓	B-4	Base	↓	
	201	1	2x4' ceiling tile		B-2	x
		↓	2	↓	↓	
	202	1	2x2' ceiling tile		B-4	.
		↓	2	↓	↓	.
	203	1	1x1' ceiling tile		1-3	.
		↓	2	↓	↓	.
	204	1	2x2' ceiling tile		1-1C	.
		↓	2	↓	↓	.
	101	A-1	Joint Tape		B-2	
		↓	B-1	Joint Compound	↓	
		↓	C-1	Drywall	↓	
✓	✓	205	A-1	Joint Tape	S-4	

Notes:  
 Yes  No  
 Negative PLM to TEM per ELAP protocols  
 Positive stop by HAN  
 Layered analysis is expected - Sample HAN-ID # \_\_\_\_\_

Sampled By: KRP

Date: 11/21/12

Relinquished By: KRP

Date: 11/21/12

Received By: \_\_\_\_\_

Date: \_\_\_\_\_

Fax/Email Report to: \_\_\_\_\_

Client/Contact:	Ram-Tech Engineers / Mike Rogalski	Turn around (circle)
Building/Location:	V.A Hospital / Bailey Ave.	RUSH      48 Hour
Job #:	SET 1941 Total # Samples: 17	24 Hour      72 Hour

Sample #				Description of Sample	Location of Sample	Notes
Date	Job	HAN	ID#			
11/21	1941	205	B-1	Joint Compound	S-4	.
		↓	C-1	Drywall	↓	.
		400	1	Mud Fittings	Sub-4	.
		↓	2	↓	↓	.
		600	1	Fire Stop Caulk	Sub S	.
		↓	2	↓	Sub 4	.
		601	1	Light Weight Cement	Sub 4	.
		↓	2	↓	Sub S	.
		602	1	Encapsulant	Sub 8	.
		↓	2	↓	Sub 7	.
		603	1	Duct Sealant - Brown	Sub 2	.
		↓	2	↓	↓	.
		604	1	Spray on Fireproofing	Sub 1	.
		↓	2	↓	↓	.
		↓	3	↓	↓	.

Notes:  
 Yes     No

Negative PLM to TEM per ELAP protocols

Positive stop by HAN

Layered analysis is expected - Sample HAN-ID # \_\_\_\_\_

Sampled By: KBD

Date: 11/21/12

Relinquished By: MRP

Date: 11/21/12

Received By: \_\_\_\_\_

Date: \_\_\_\_\_



350 Elmwood Ave. • Buffalo, NY 14222  
 (P) 716.332.3134 (F) 716.332.3136

## Chain of Custody Document

Fax/Email Report to: \_\_\_\_\_

Client/Contact: <u>Ram-Tech Engineers / Mike Rogalski</u>	Turn around (circle)
Building/Location: <u>V.A Hospital / Buffalo - Bailey Ave.</u>	RUSH      48 Hour
Job #: <u>SET 1941</u> Total # Samples: <u>47</u>	24 Hour <u>72-Hour</u>

PLM     TEM     AAS     OTHER

Sample #				Description of Sample	Location of Sample	Notes
Date	Job	HAN	ID#			
11/21	1941	b07	1	Duct Sealant - Grey	B-S	1
↓	↓	↓	2	↓	↓	.

Notes:	<input checked="" type="checkbox"/> Yes <input type="checkbox"/> No	Negative PLM to TEM per ELAP protocols
	<input checked="" type="checkbox"/>	Positive stop by HAN
	<input checked="" type="checkbox"/>	Layered analysis is expected - Sample HAN-ID # _____


Sampled By: RKD    Date: 11/21/12


Relinquished By: RKD    Date: 11/21/12

Received By: \_\_\_\_\_    Date: \_\_\_\_\_




## **Appendix D Asbestos Sample Floor Plans**

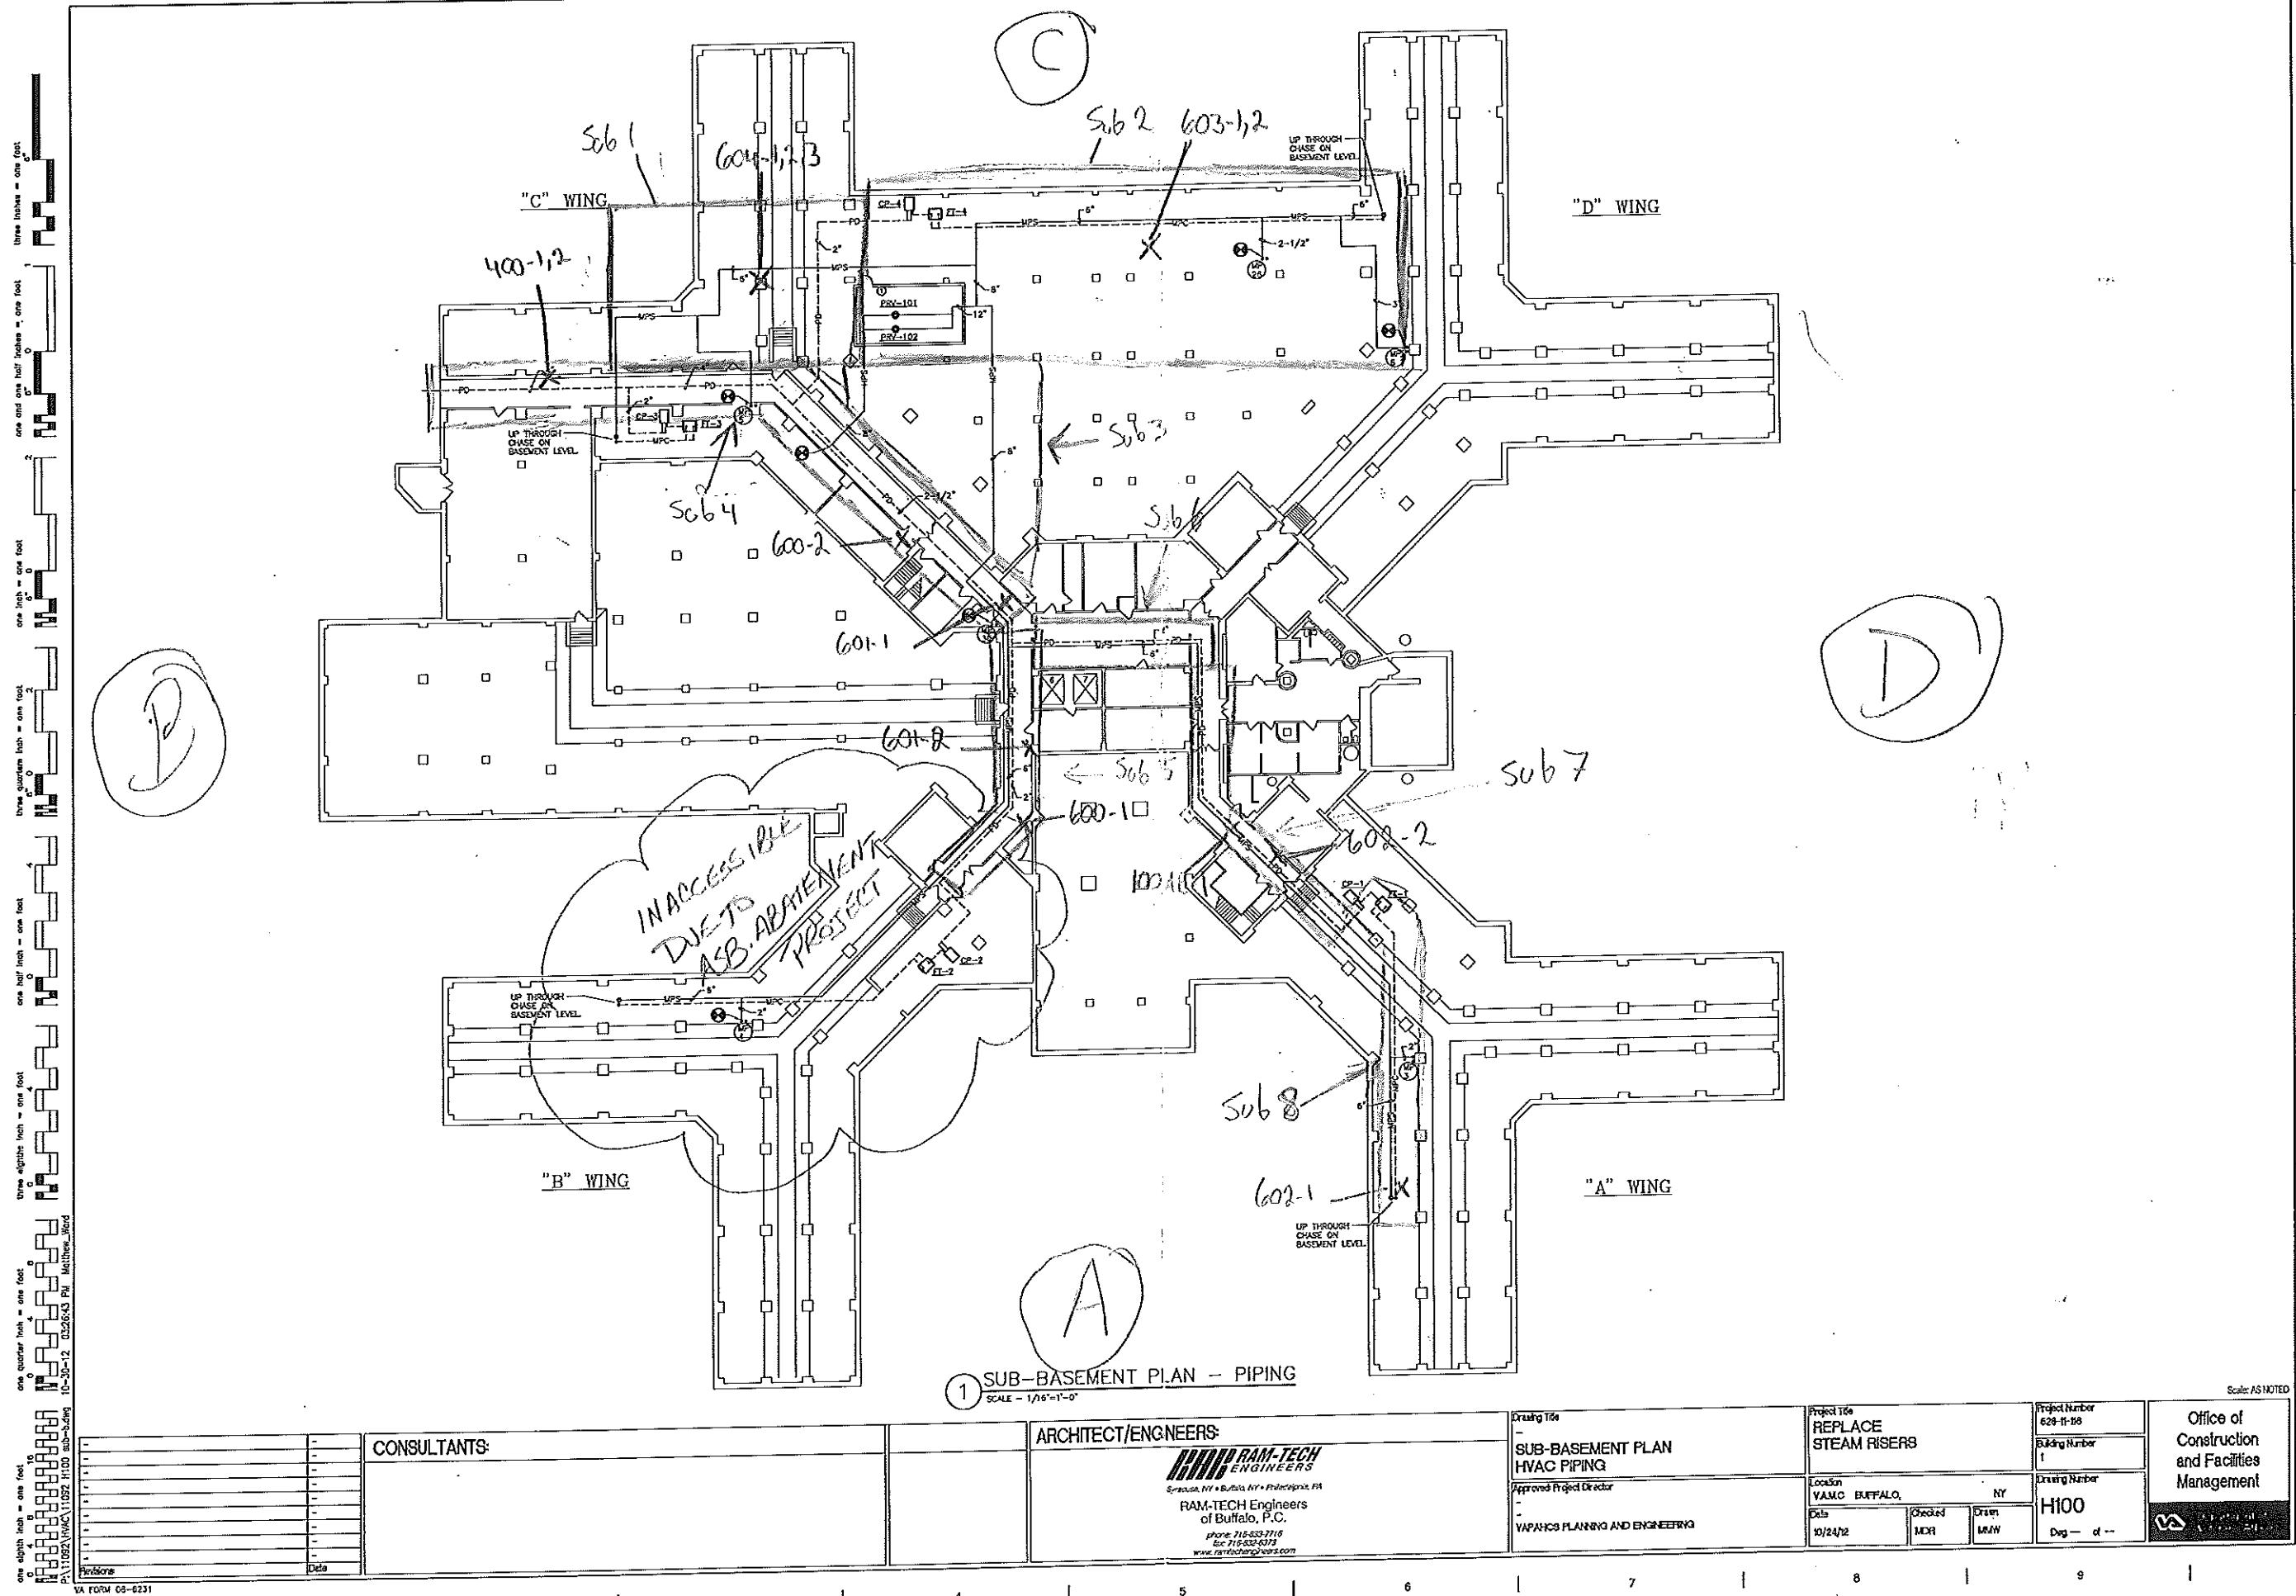


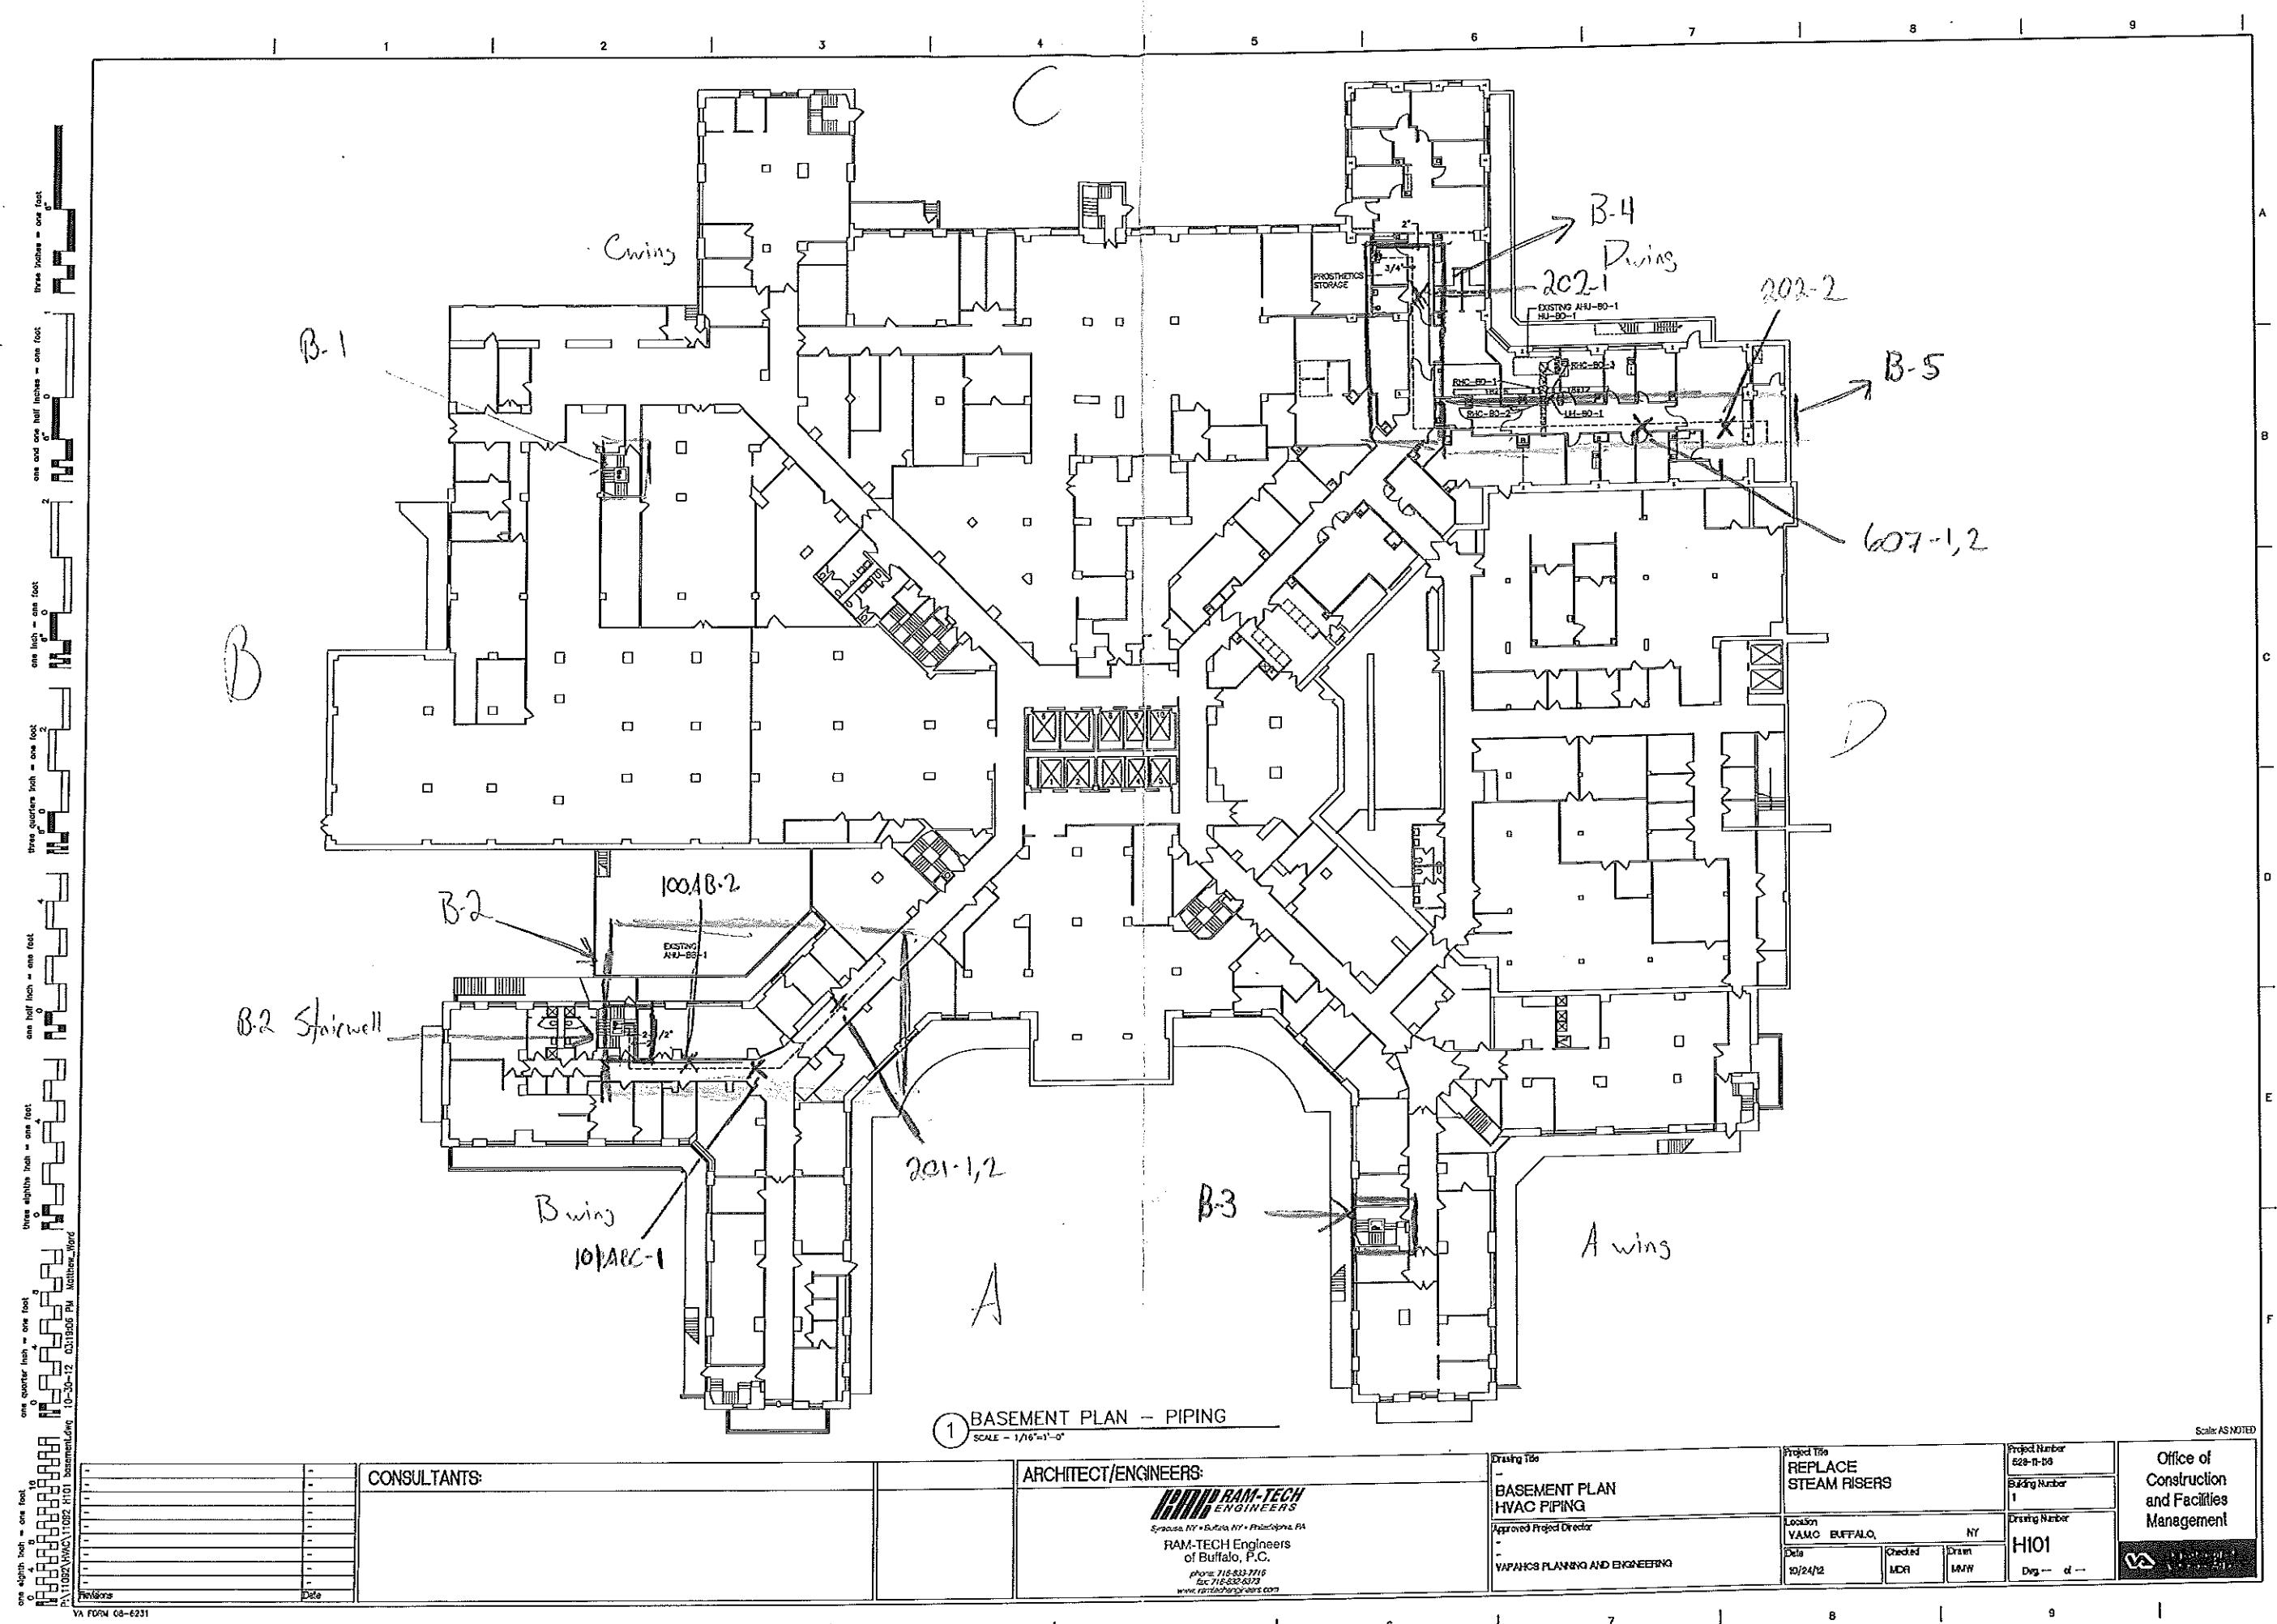

1	2	3	4	5	6	7	8	9	10	
one eighth inch = one foot 0 1 2 3 4 5 6 7 8 9 10	one quarter inch = one foot 0 1 2 3 4 5 6 7 8 9 10	three eighths inch = one foot 0 1 2 3 4 5 6 7 8 9 10	one half inch = one foot 0 1 2 3 4 5 6 7 8 9 10	one inch = one foot 0 1 2 3 4 5 6 7 8 9 10	one and one half inches = one foot 0 1 2 3 4 5 6 7 8 9 10	two inches = one foot 0 1 2 3 4 5 6 7 8 9 10				
PL 11092 WNC 11092 11092 10-30-12 Revisions Date	PL 11092 WNC 11092 11092 10-30-12 Revisions Date	PL 11092 WNC 11092 11092 10-30-12 Revisions Date	PL 11092 WNC 11092 11092 10-30-12 Revisions Date	PL 11092 WNC 11092 11092 10-30-12 Revisions Date	PL 11092 WNC 11092 11092 10-30-12 Revisions Date	PL 11092 WNC 11092 11092 10-30-12 Revisions Date	PL 11092 WNC 11092 11092 10-30-12 Revisions Date	PL 11092 WNC 11092 11092 10-30-12 Revisions Date	PL 11092 WNC 11092 11092 10-30-12 Revisions Date	PL 11092 WNC 11092 11092 10-30-12 Revisions Date
<p style="text-align: center;">1 FIRST FLOOR PLAN → PIPING</p> <p style="text-align: center;">SCALE - 1/16"=1'-0"</p>										
Scale AS NOTED										
CONSULTANTS:			ARCHITECT/ENGINEERS:			Drawing No.			Project No.	
			<b>RAM-TECH</b> <b>ENGINEERS</b> Syracuse, NY • Buffalo, NY • Philadelphia, PA RAM-TECH Engineers of Buffalo, P.C. phone: 716-632-7716 fax: 716-632-5773 <a href="http://www.ramtech-engineers.com">www.ramtech-engineers.com</a>			100-1000-1000 FIRST FLOOR PLAN HVAC PIPING			628-11-08 Building Number 1	
			Approved Project Director VAPAHOS PLANNING AND ENGINEERING			Location VAMC BUFFALO, NY			Drawing Number H102 Dwg. — d —	
			Date 10/24/12			Checklist Mod. <input type="checkbox"/> Draw. <input type="checkbox"/> MMW <input type="checkbox"/>			Office of Construction and Facilities Management	

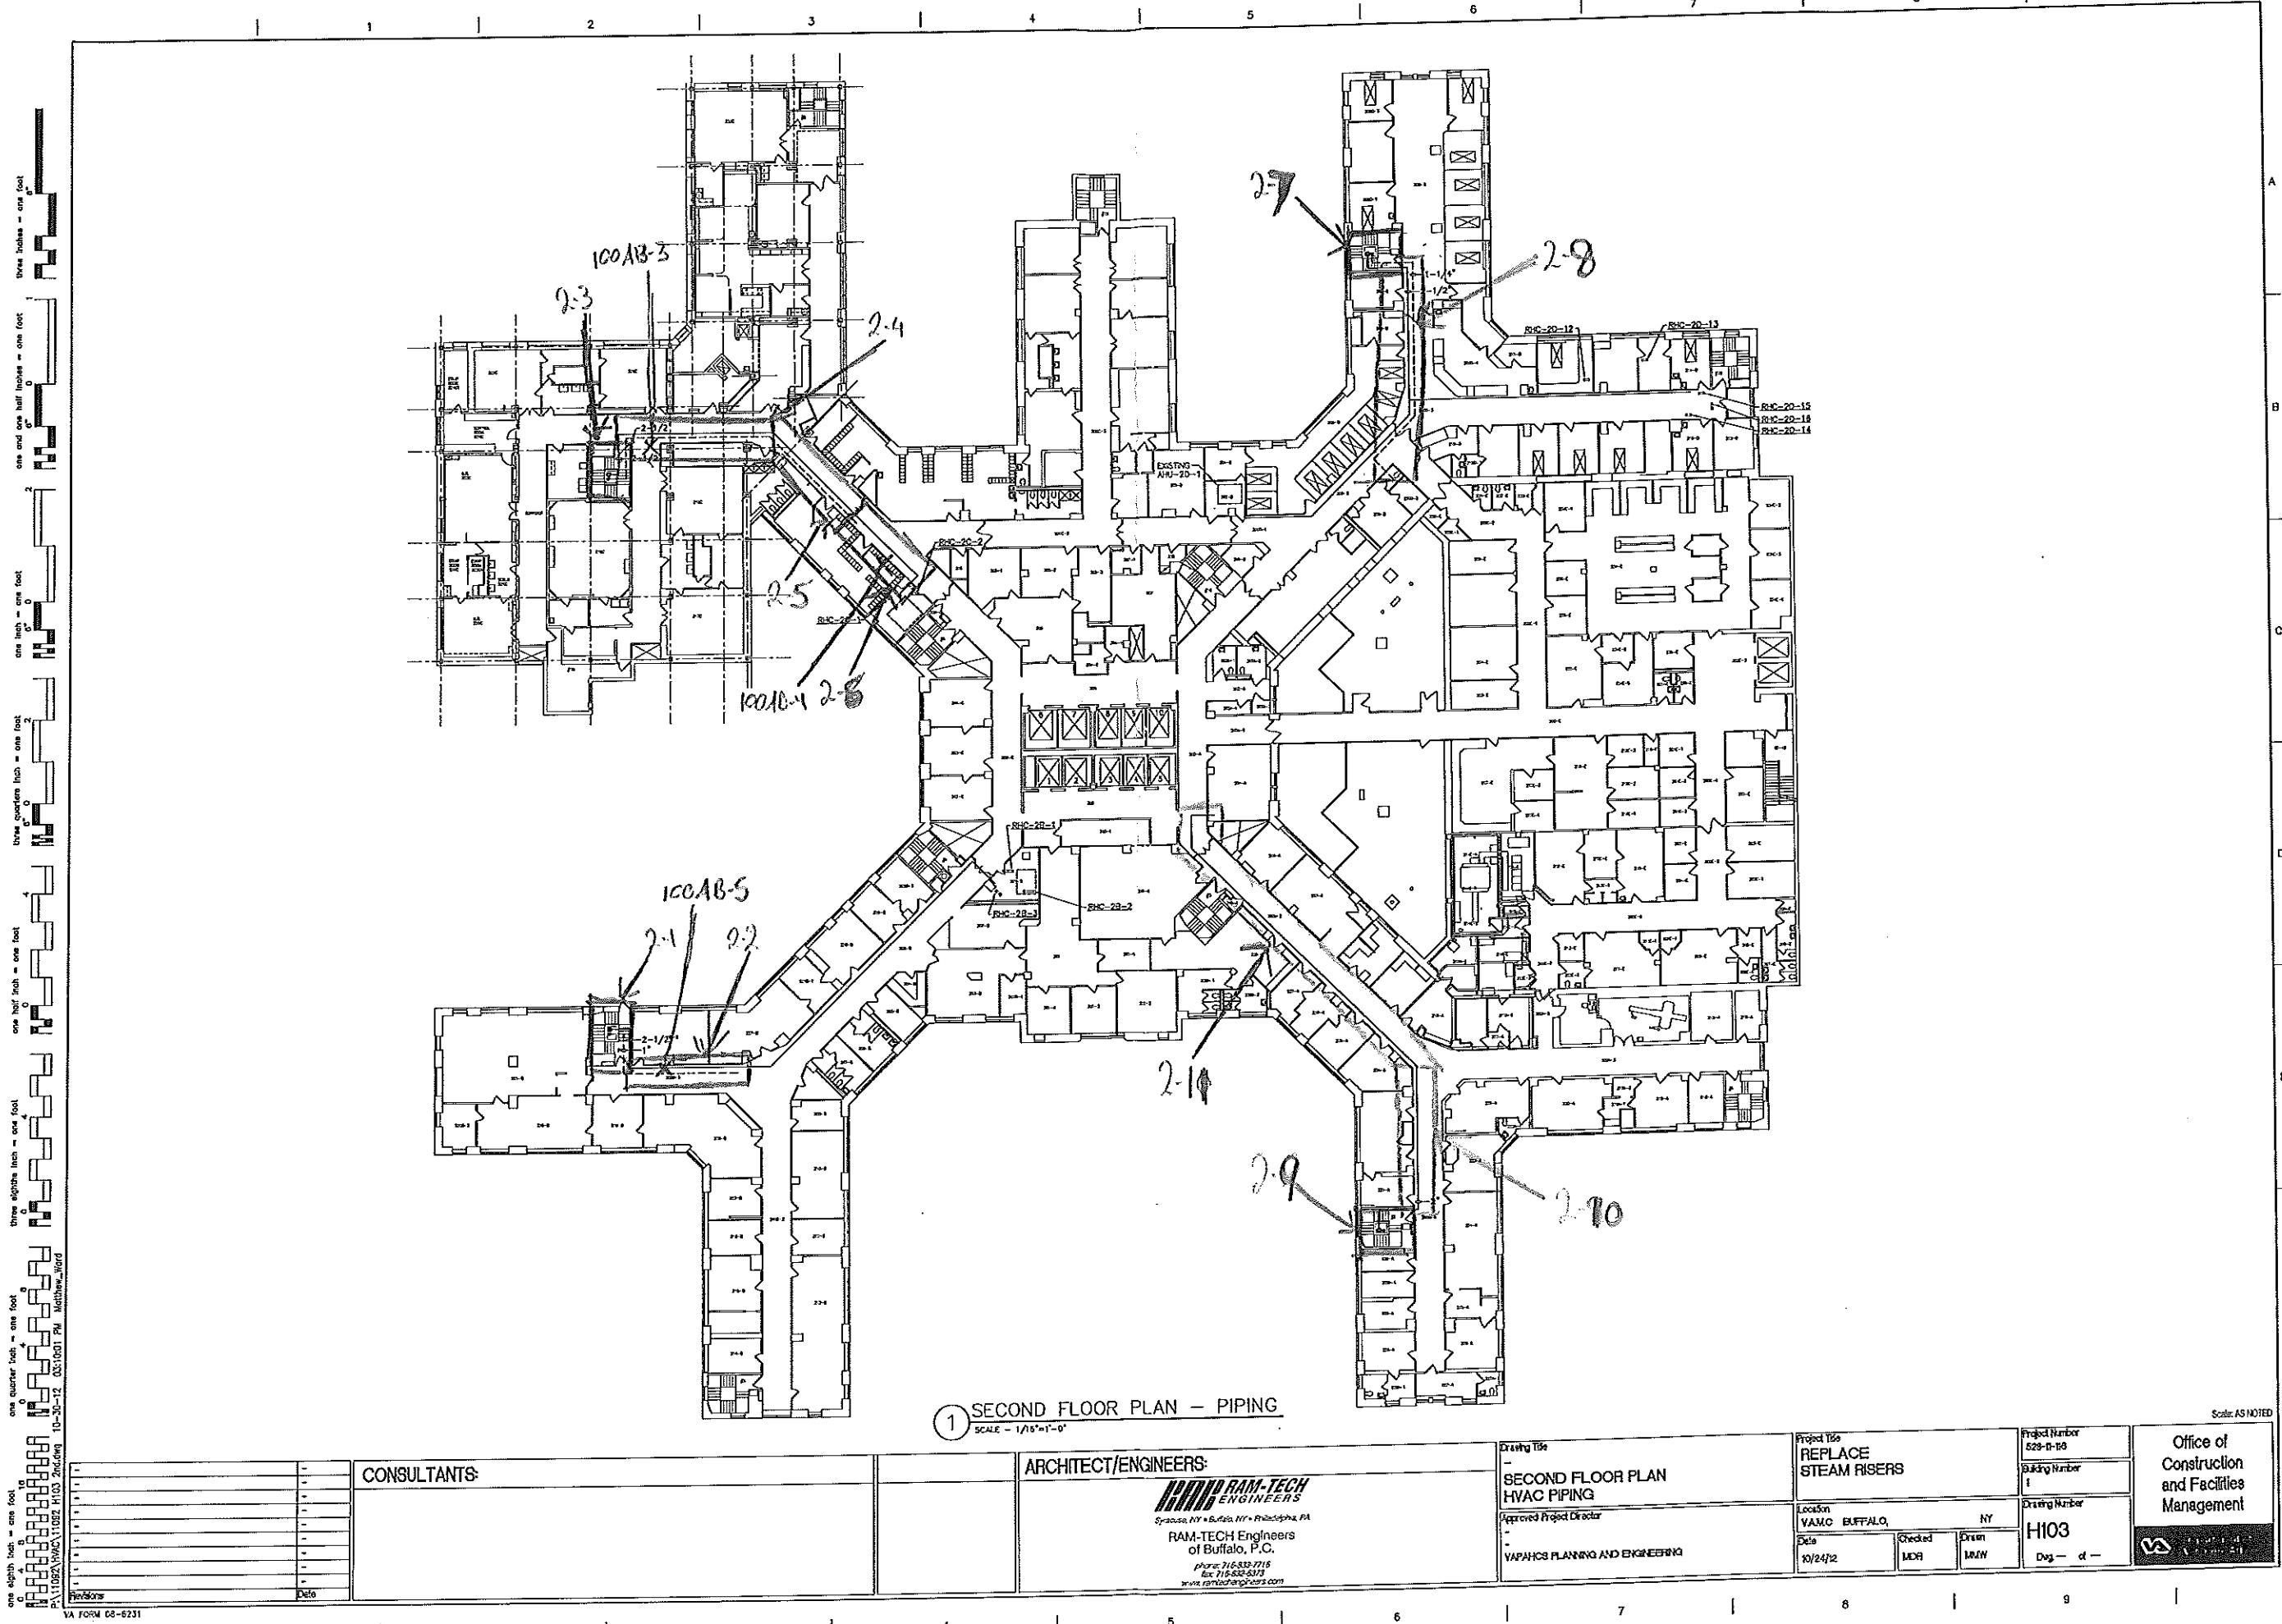

one eighth inch = one foot  
 one quarter inch = one foot  
 one half inch = one foot  
 one inch = one foot  
 one and one half inches = one foot  
 three inches = one foot

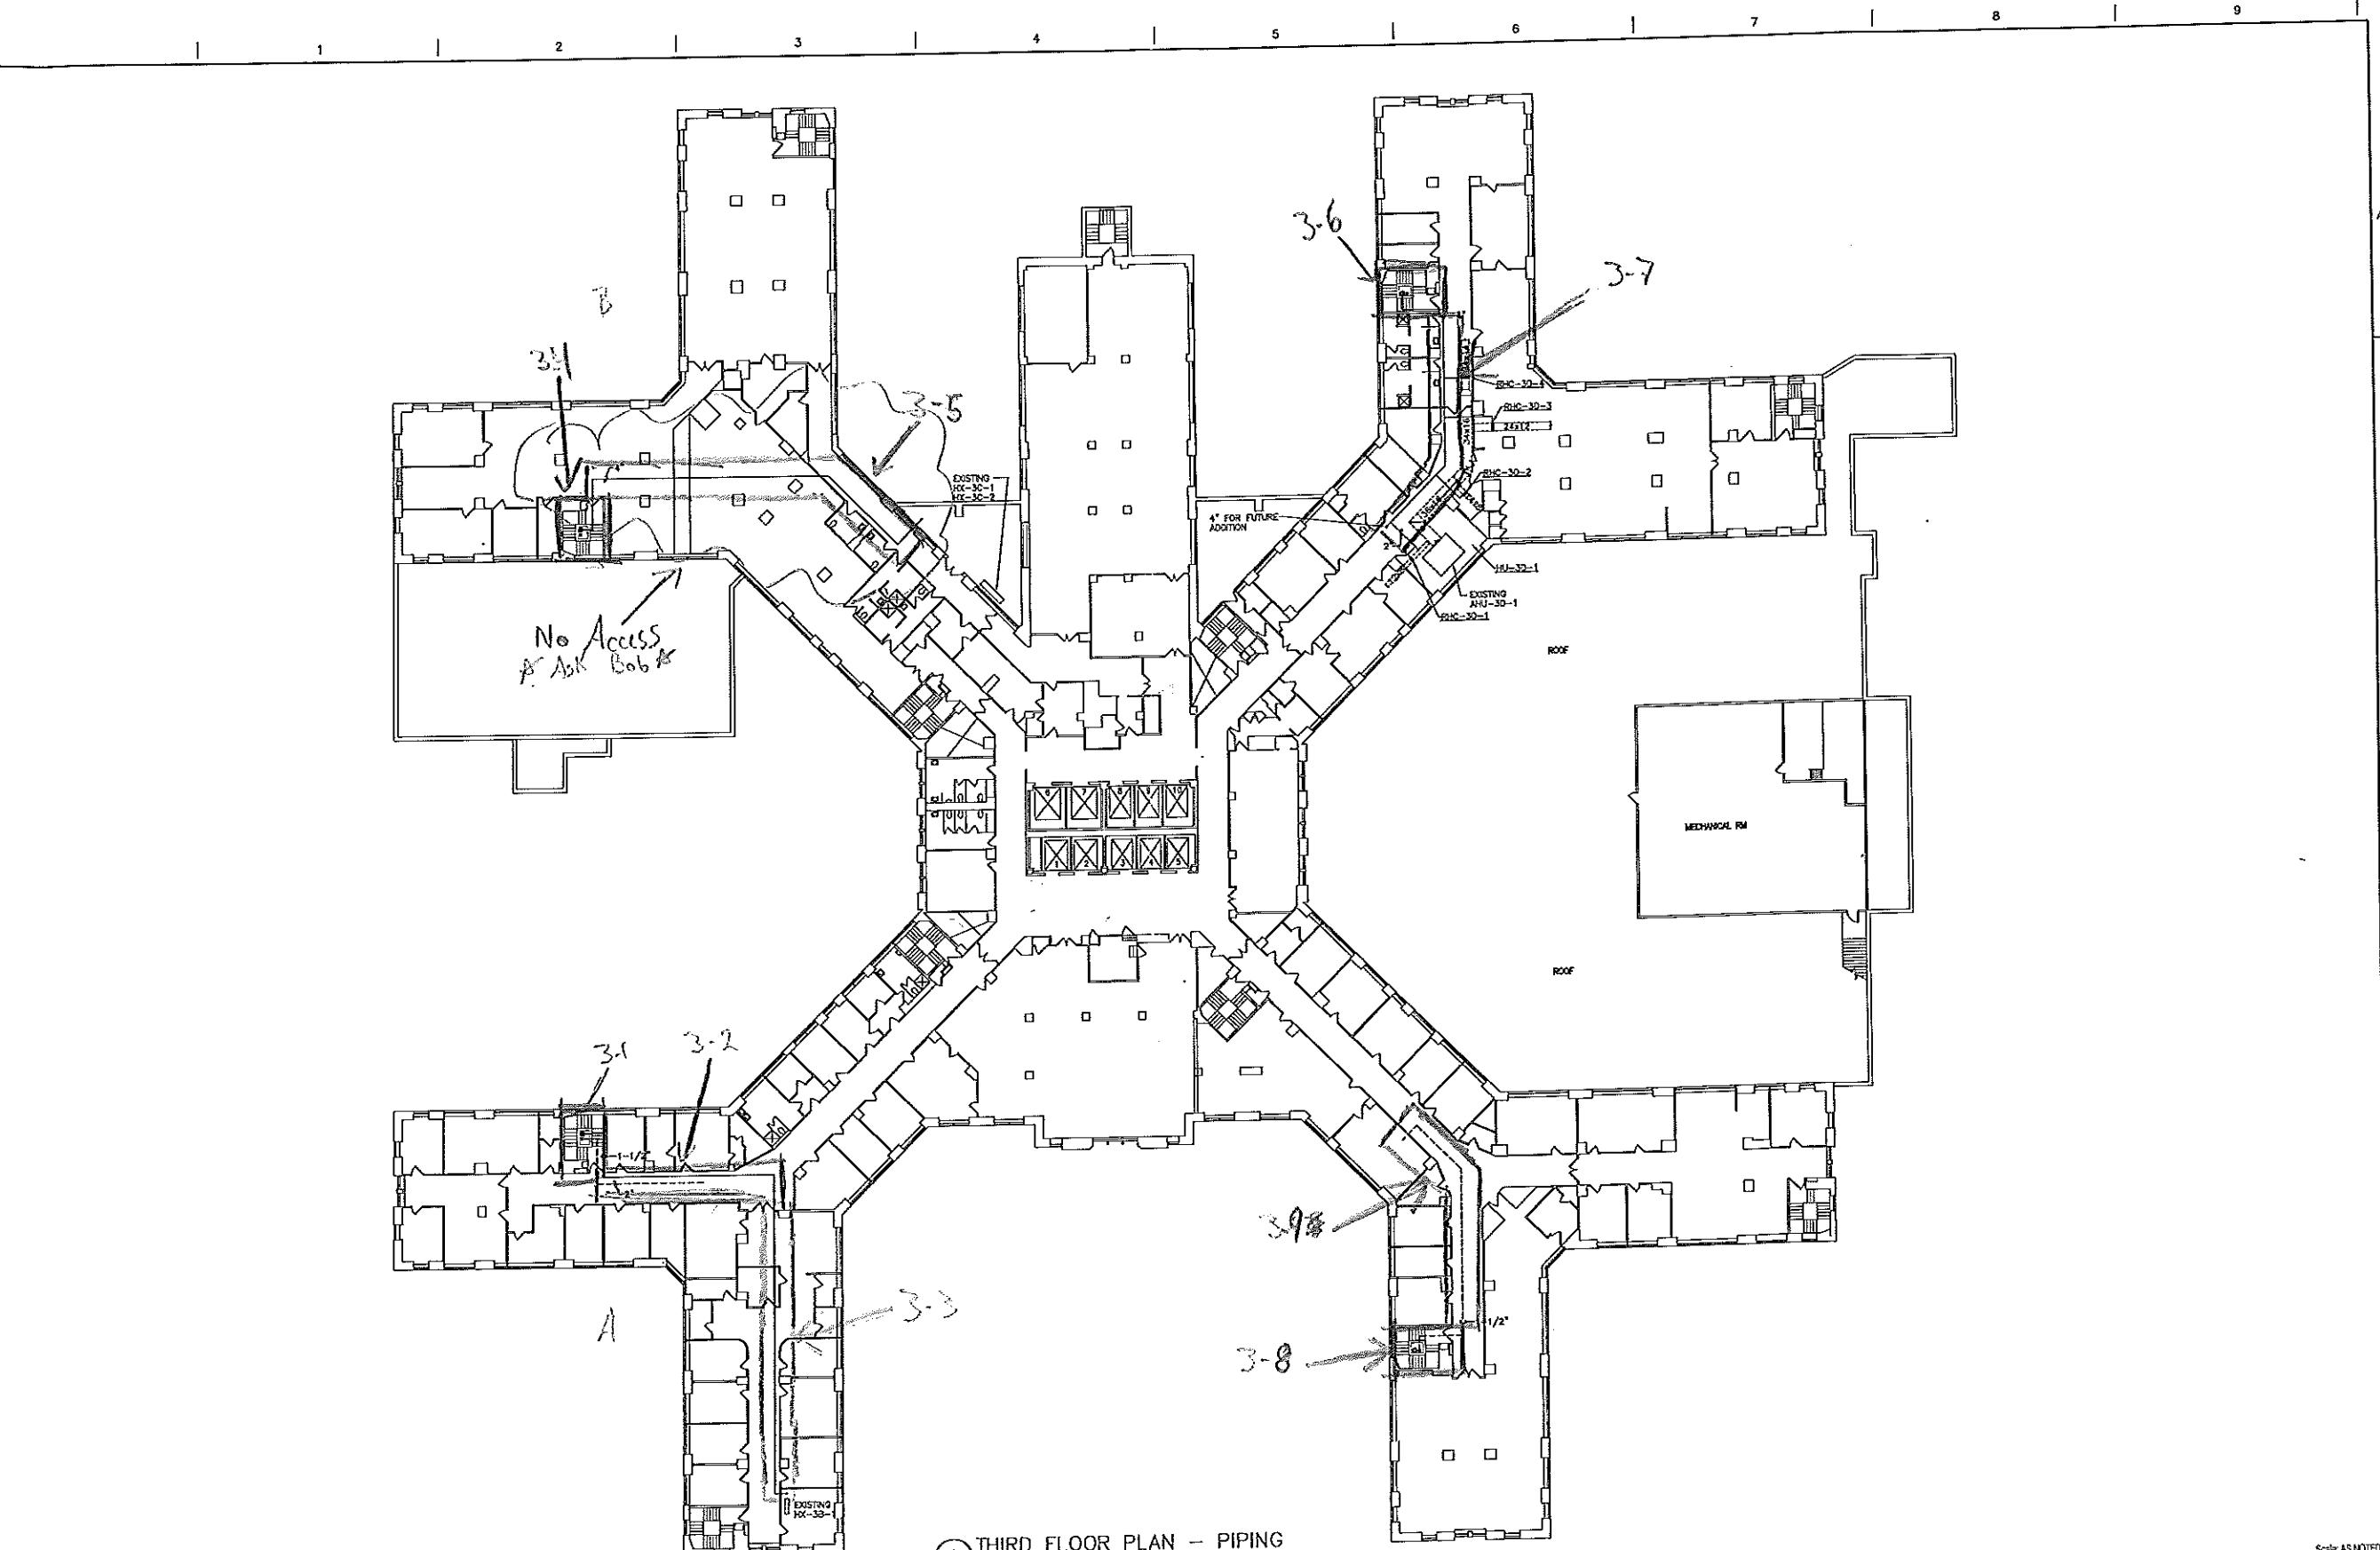

① THIRD FLOOR PLAN - PIPING  
SCALE - 1/16"=1'-0"

CONSULTANTS:

ARCHITECT/ENGINEERS:

**RAM-TECH  
ENGINEERS**  
Syracuse, NY • Buffalo, NY • Philadelphia, PA  
RAM-TECH Engineers  
of Buffalo, P.C.  
Phone: 716-632-2710  
Fax: 716-632-6173  
[www.ramtechengineers.com](http://www.ramtechengineers.com)

Drawing Title

THIRD FLOOR PLAN  
HVAC PIPING

Approved Project Director

VAPAHCO PLANNING AND ENGINEERING

Project No.

REPLACE  
STEAM RISERS

Building Number

1

Drawing Number

H104

Date

10/24/12

Checked

MCR

Drawn


MCR

Office of  
Construction  
and Facilities  
Management



Scale AS NOTED

one depth inch = one foot  
 one diameter inch = one foot  
 three eighths inch = one foot  
 one half inch = one foot  
 one inch = one foot  
 one and one half inches = one foot  
 two inches = one foot

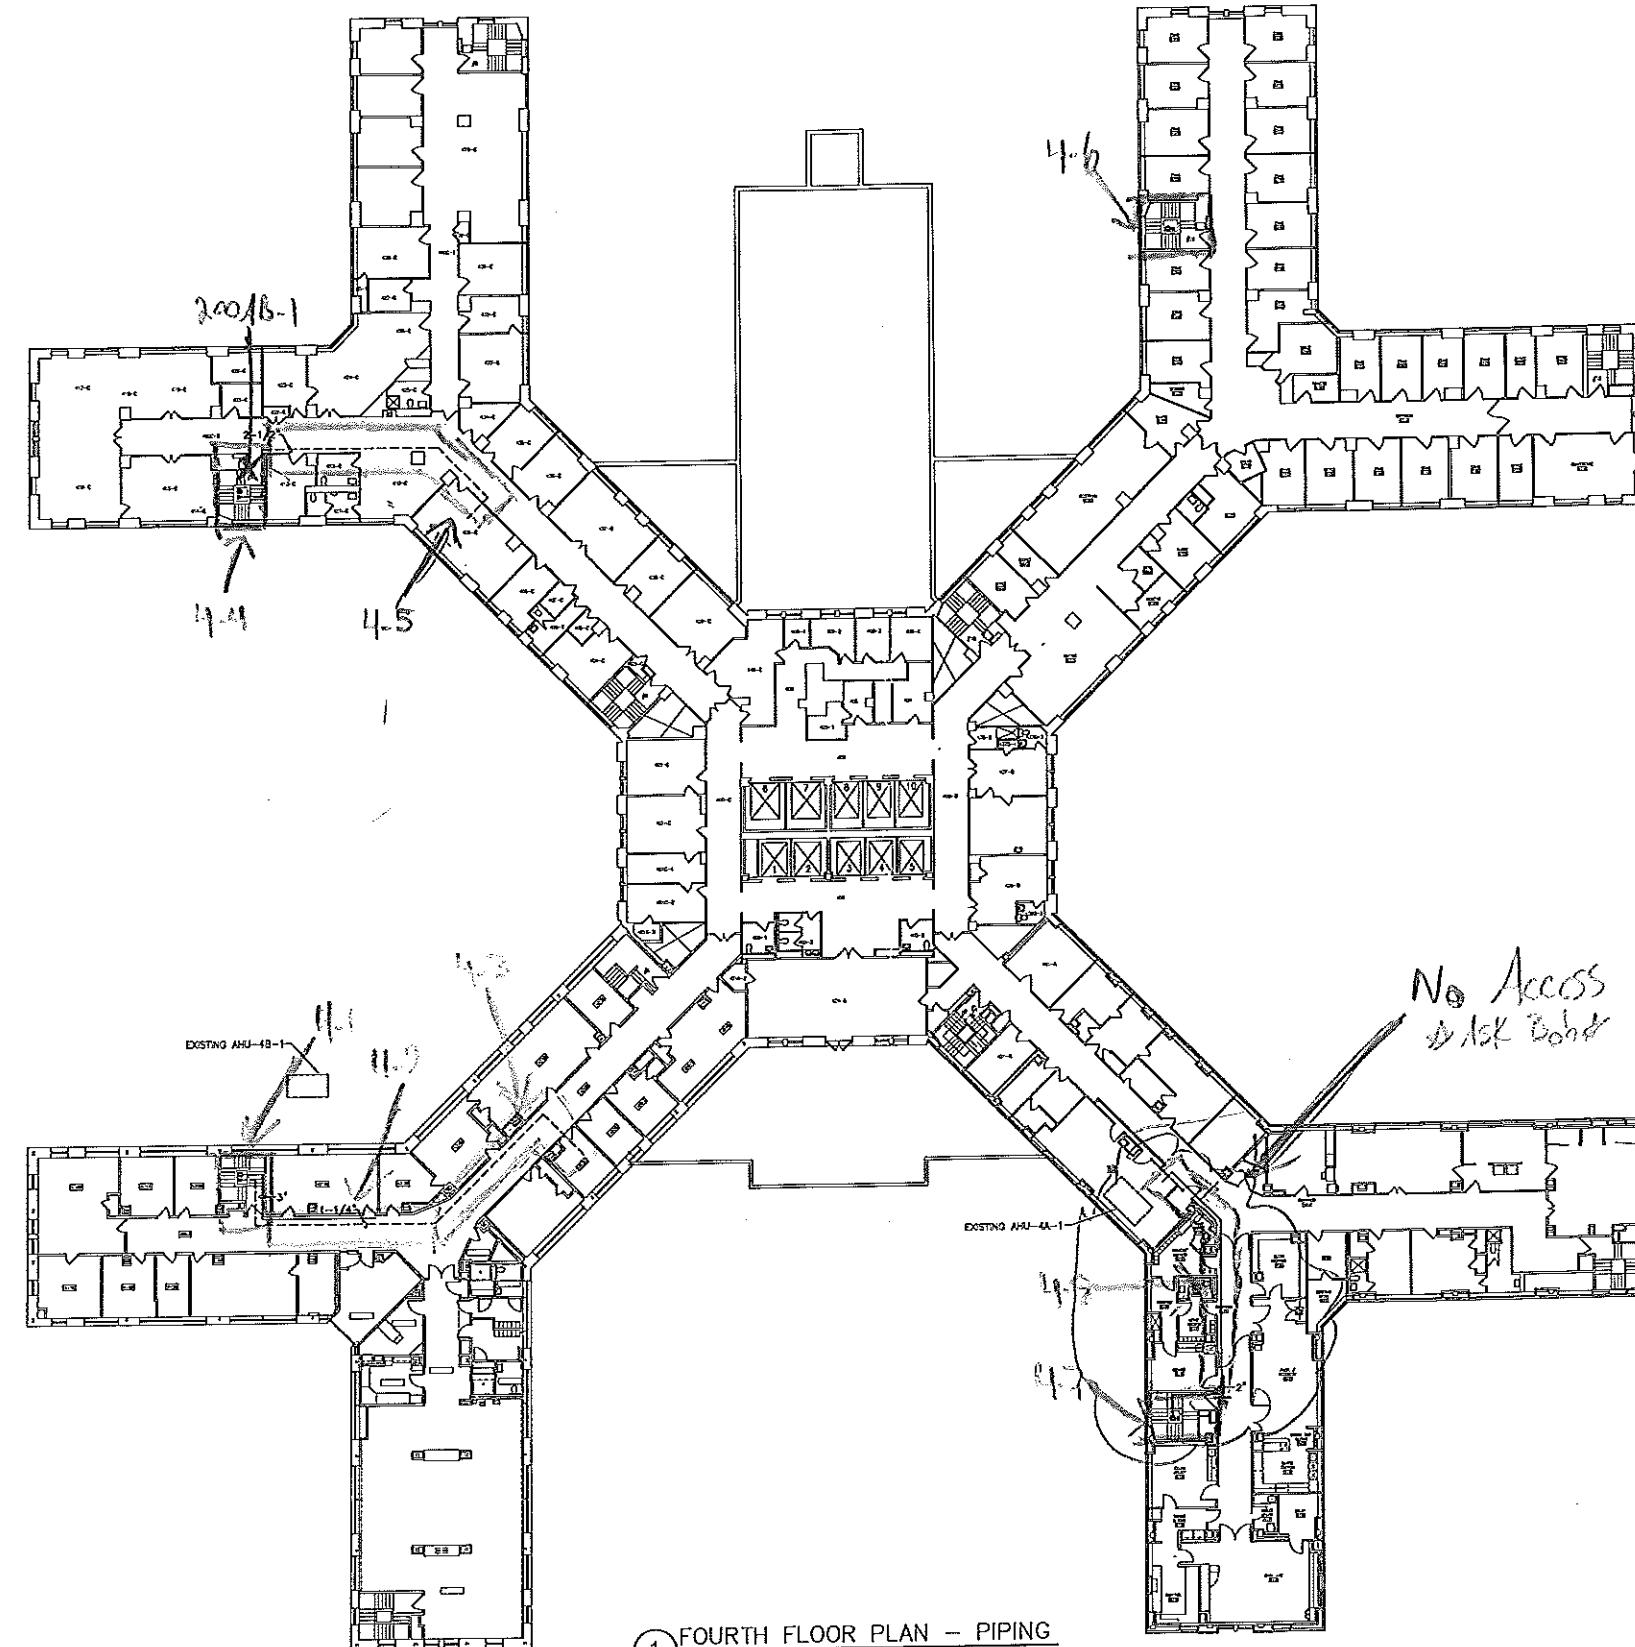

1 FOURTH FLOOR PLAN - PIPING

SCALE - 1/16"-1'-0"

CONSULTANTS:

ARCHITECT/ENGINEERS:



Syracuse, NY • Buffalo, NY • Philadelphia, PA

RAM-TECH Engineers

of Buffalo, P.C.

Phone 716-633-7716

Fax 716-633-7717

www.ram-tech.com

Drawing Title:  
FOURTH FLOOR PLAN  
HVAC PIPING

Approved Project Director:  
VAFANOS PLANNING AND ENGINEERING


Project Title:  
REPLACE  
STEAM RISERS

Location:  
VAMC BUFFALO,  
NY  
Date:  
10/24/02  
Checked:  
MDR  
Drawn:  
MMW  
Dwg. No.:  
H105  
Dwg. -- d --

Project Number:  
628-H-1a  
Building Number:  
1  
Drawing Number:  
H105


Office of  
Construction  
and Facilities  
Management

Scale AS NOTED

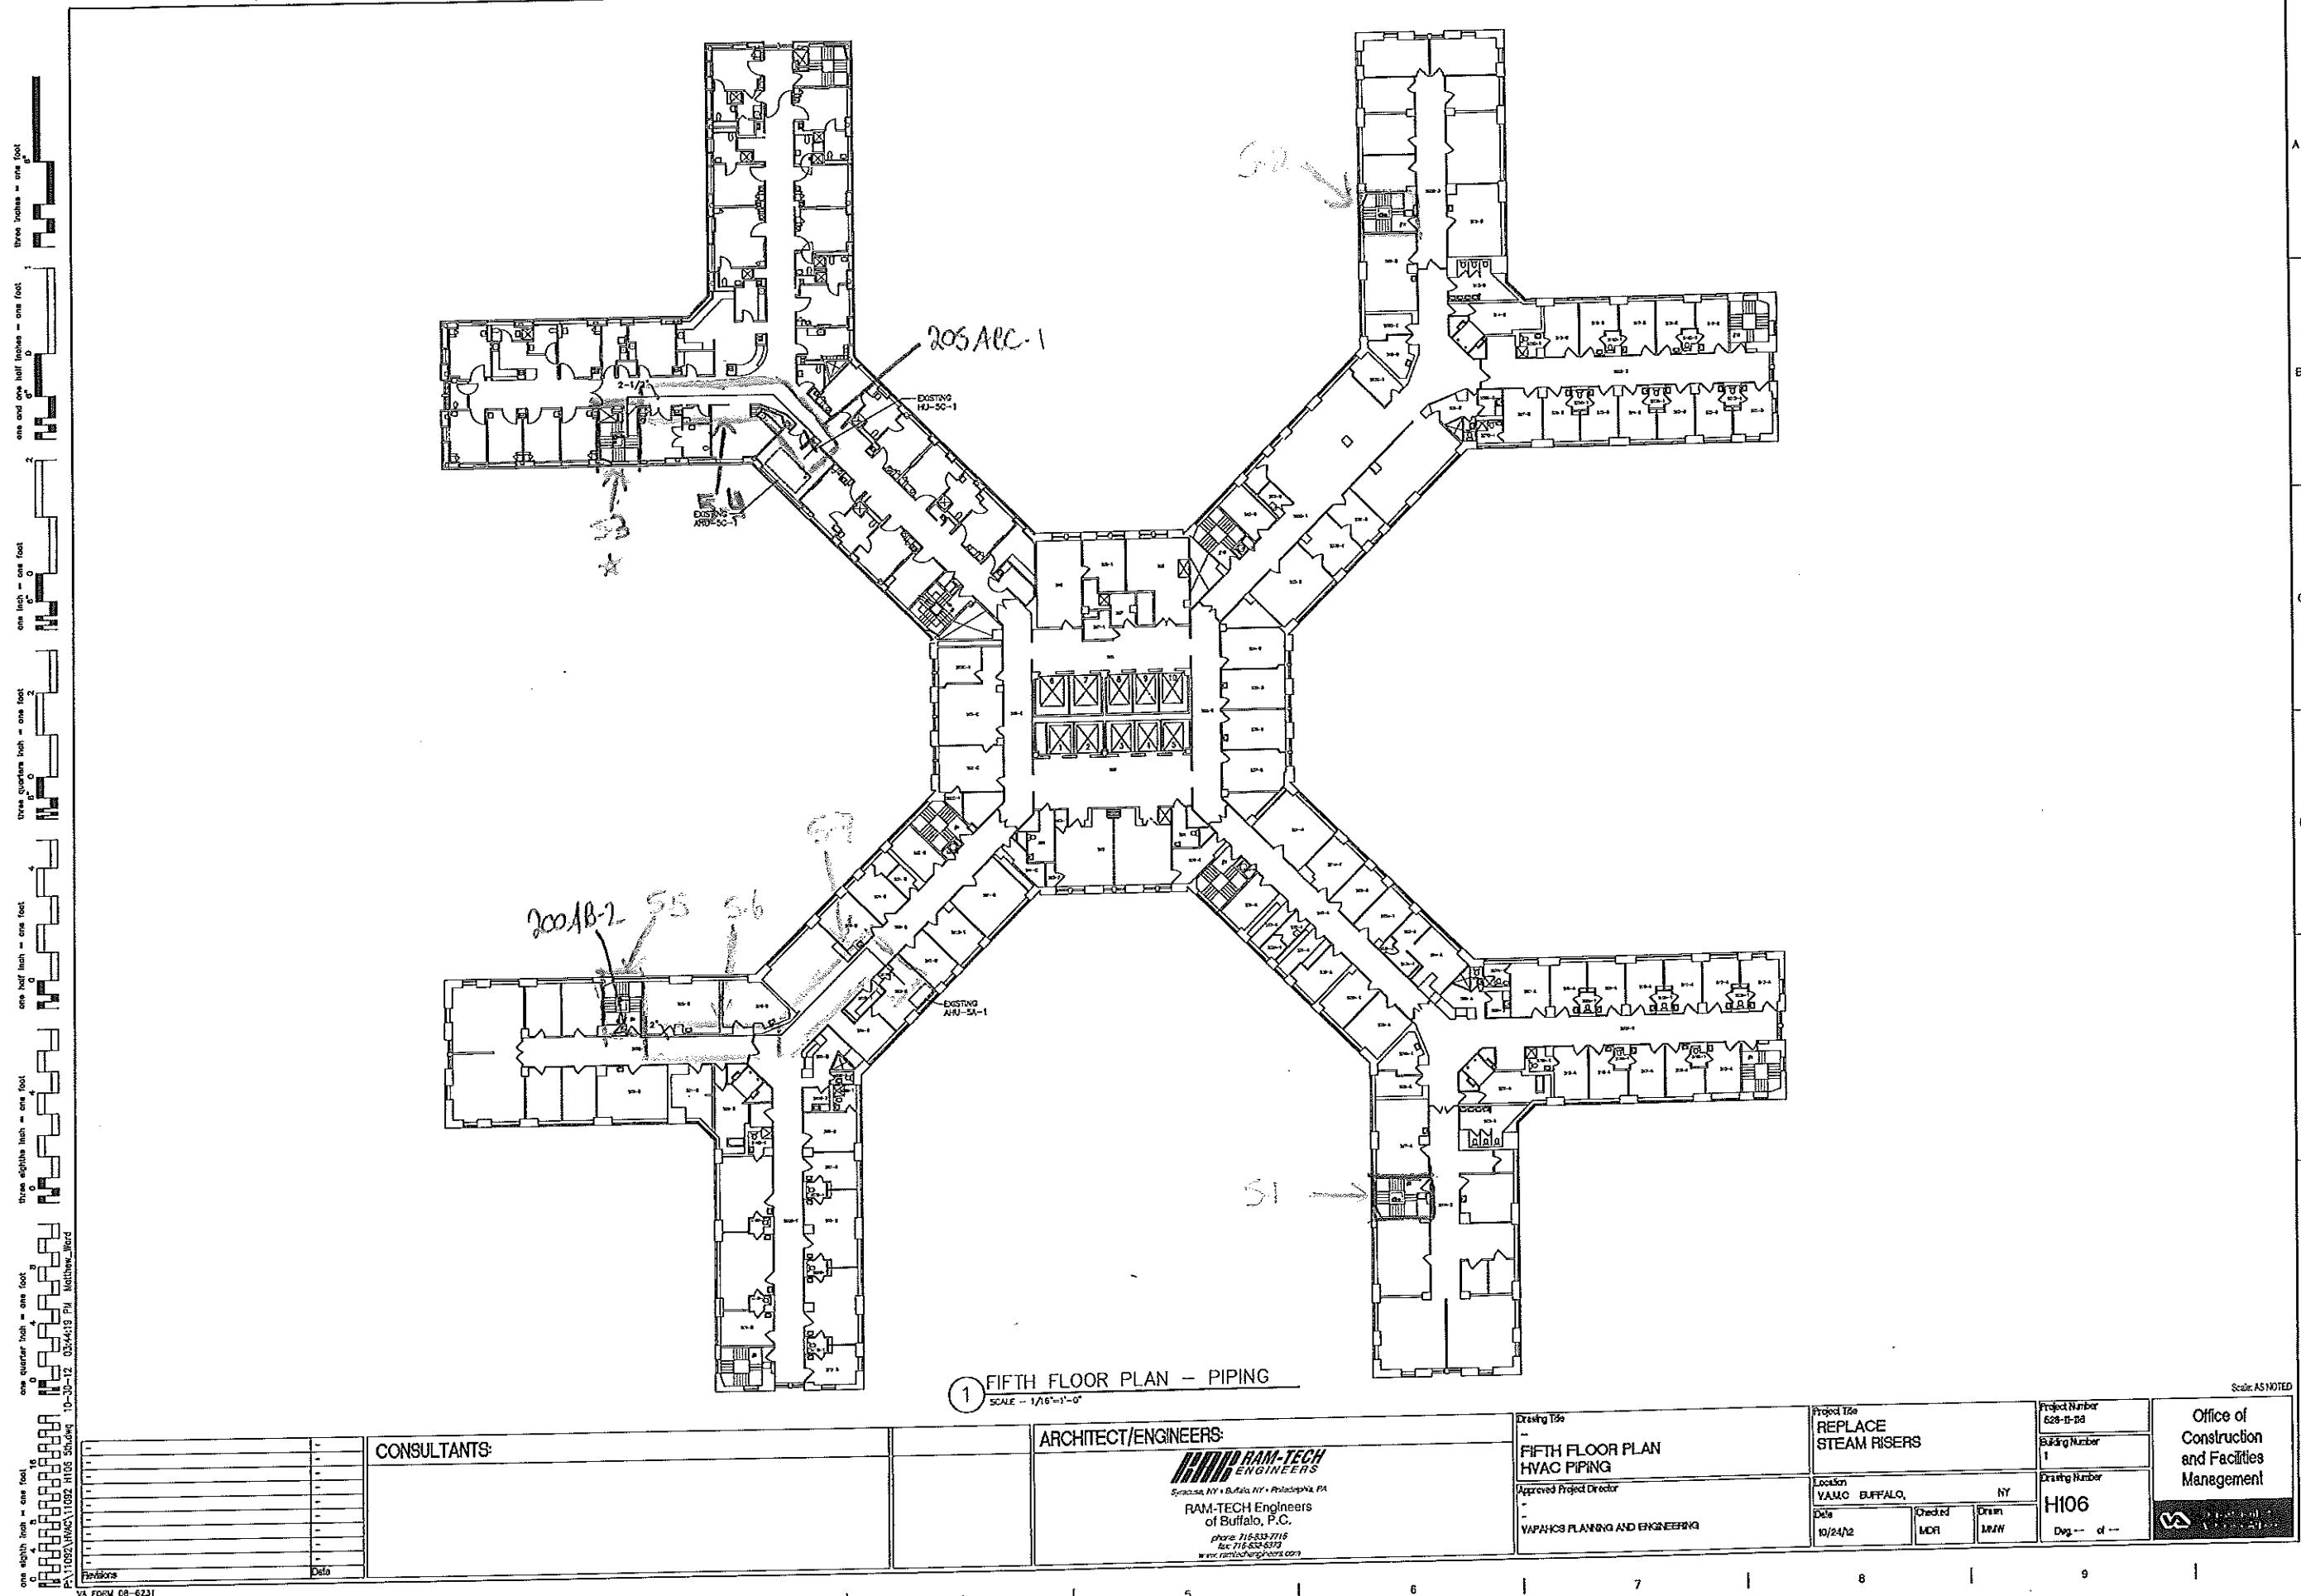

1	2	3	4	5	6	7	8	9
1 SIXTH FLOOR PLAN - PIPING								
SCALE - 1/8"=1'-0"								
<b>CONSULTANTS:</b> _____			<b>ARCHITECT/ENGINEERS:</b>  Syracuse, NY • Buffalo, NY • Philadelphia, PA RAM-TECH Engineers of Buffalo, P.C. Phone: 716-633-7716 Fax: 716-633-6772 <a href="http://www.ramtechengineers.com">www.ramtechengineers.com</a>			<b>Drawing No.</b> - <b>SIXTH FLOOR PLAN</b> <b>HVAC PIPING</b> <b>Approved Project Director</b> - <b>VAPANICS PLANNING AND ENGINEERING</b>		
<b>Project No.</b> 629-11-18 <b>Building Number</b> 1			<b>Project No.</b> 629-11-18 <b>Building Number</b> 1			<b>Location</b> VAMO BUFFALO, NY <b>Date</b> 10/24/12 <b>Checked</b> MDR <b>Drawn</b> MMW <b>Designated</b> H107      d		
<b>Office of Construction and Facilities Management</b> 								

one eighth inch = one foot  
one quarter inch = one foot  
three eighths inch = one foot  
one half inch = one foot  
one and one half inches = one foot  
three quarters inch = one foot  
one inch = one foot  
one and one half inches = one foot  
three inches = one foot

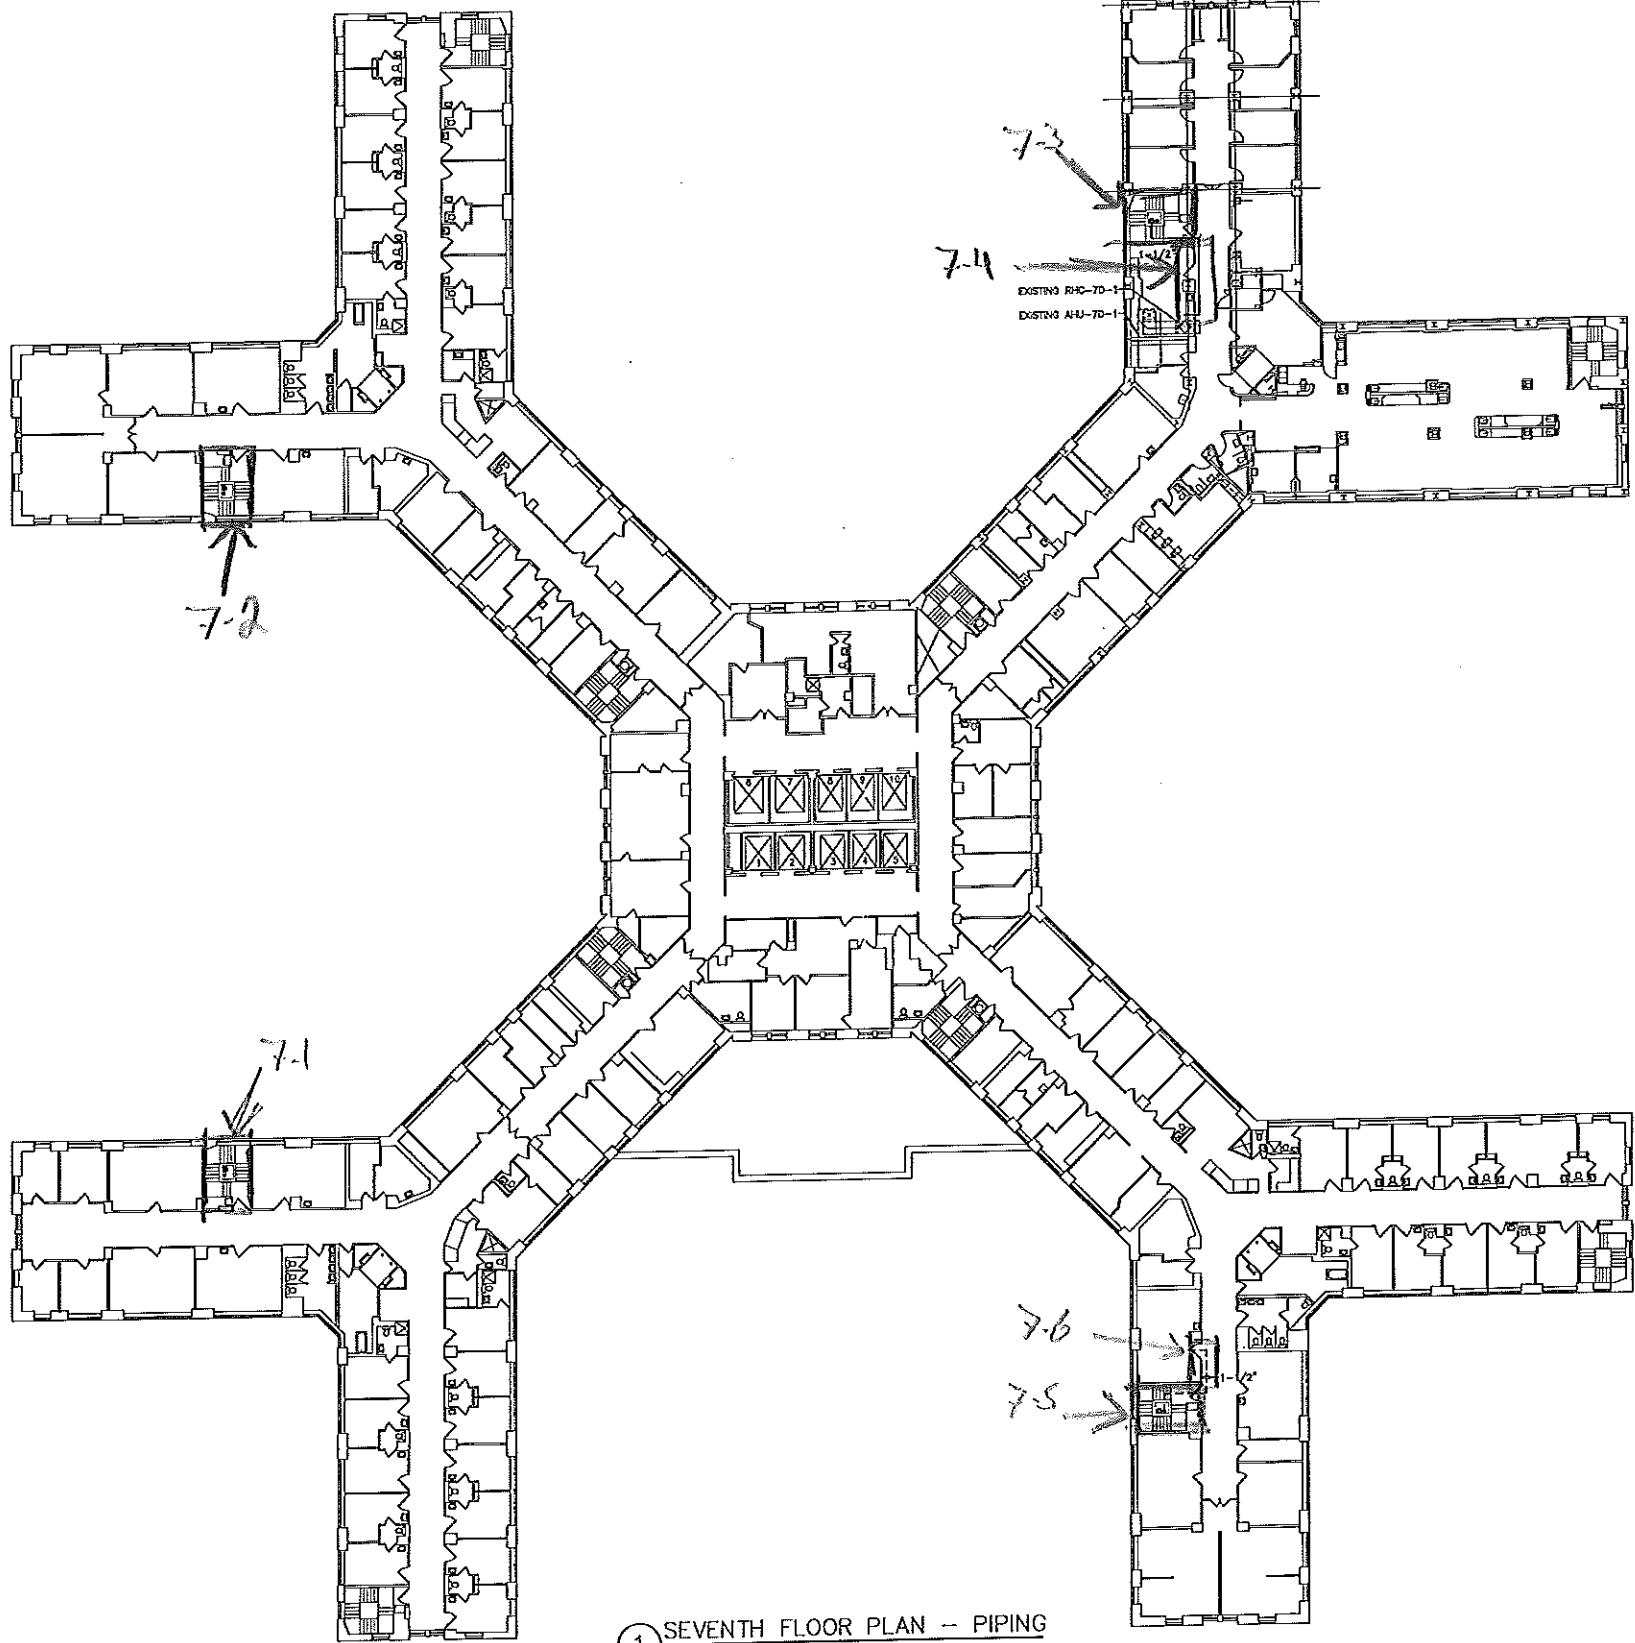

1 SEVENTH FLOOR PLAN - PIPING

SCALE - 1/8"=1'-0"

CONSULTANTS

ARCHITECT/ENGINEERS:

**RAM-TECH  
ENGINEERS**  
Syracuse, NY & Buffalo, NY • Philadelphia, PA  
RAM-TECH Engineers  
of Buffalo, P.C.  
Phone: 716-533-7116  
Fax: 716-533-6373  
[www.ramtech-engineers.com](http://www.ramtech-engineers.com)

Drawing No.	Project No.
-	628-11-16
SEVENTH FLOOR PLAN HVAC PIPING	Building Number
Approved Project Director	1


VAFAHCS PLANNING AND ENGINEERING

Location	Project No.
VAMC BUFFALO, NY	Building Number
Date 10/24/12	H108
Checked MDR	Drawn MMW
Dug d	

Office of Construction and Facilities Management	
10/24/12	MMW

Scale AS NOTED

one eighth inch = one foot  
one quarter inch = one foot  
three sixteenths inch = one foot  
one half inch = one foot  
one and one half inches = one foot  
three inches = one foot

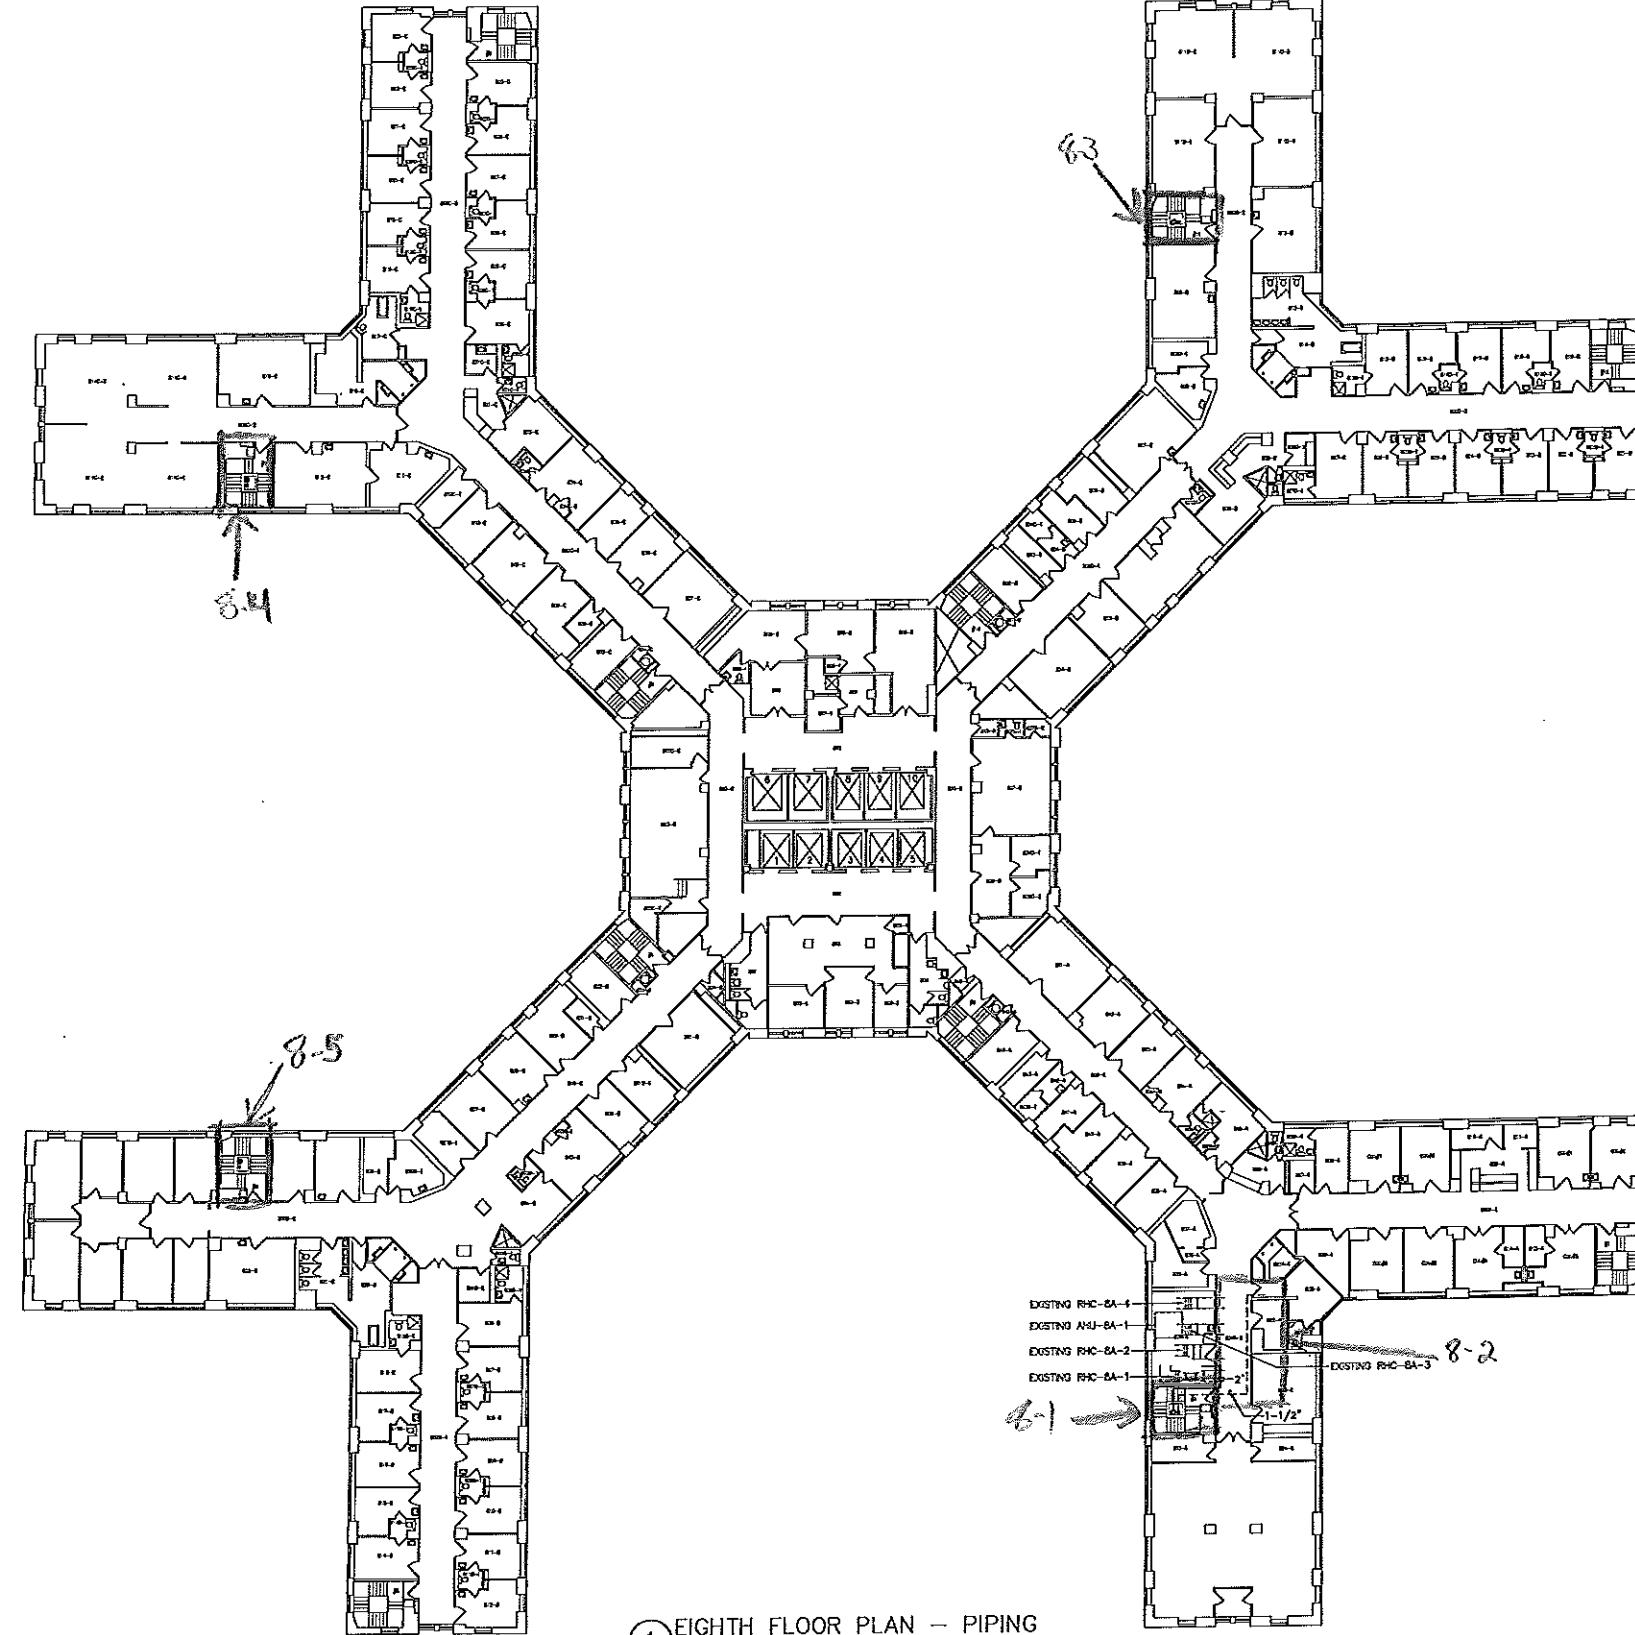

1 EIGHTH FLOOR PLAN - PIPING

SCALE - 1/16=1'-0"

CONSULTANTS:	
P-11052-WAC11052-HGS Shoring 10-30-12	Date
Comments	

CONSULTANTS:

ARCHITECT/ENGINEERS:

**RAM-TECH  
ENGINEERS**  
Syracuse, NY • Buffalo, NY • Philadelphia, PA  
RAM-TECH Engineers  
of Buffalo, P.C.  
Phone: 716-622-4115  
Fax: 716-622-4119  
[www.ramtechengineers.com](http://www.ramtechengineers.com)

Drawing No.

EIGHTH FLOOR PLAN  
HVAC PIPING

Approved Project Director  
YAPAHOS PLANNING AND ENGINEERING

Project Title

REPLACE  
STEAM RISERS

Location  
VAMC BUFFALO, NY  
Date  
10/24/12  
Checked  
MOR  
Drawn  
MMW  
Dwg -- d --

Project Number


H22-R-08  
Building Number  
1

Drawing Number  
H109  
Dwg -- d --

Scale AS NOTED

Office of  
Construction  
and Facilities  
Management



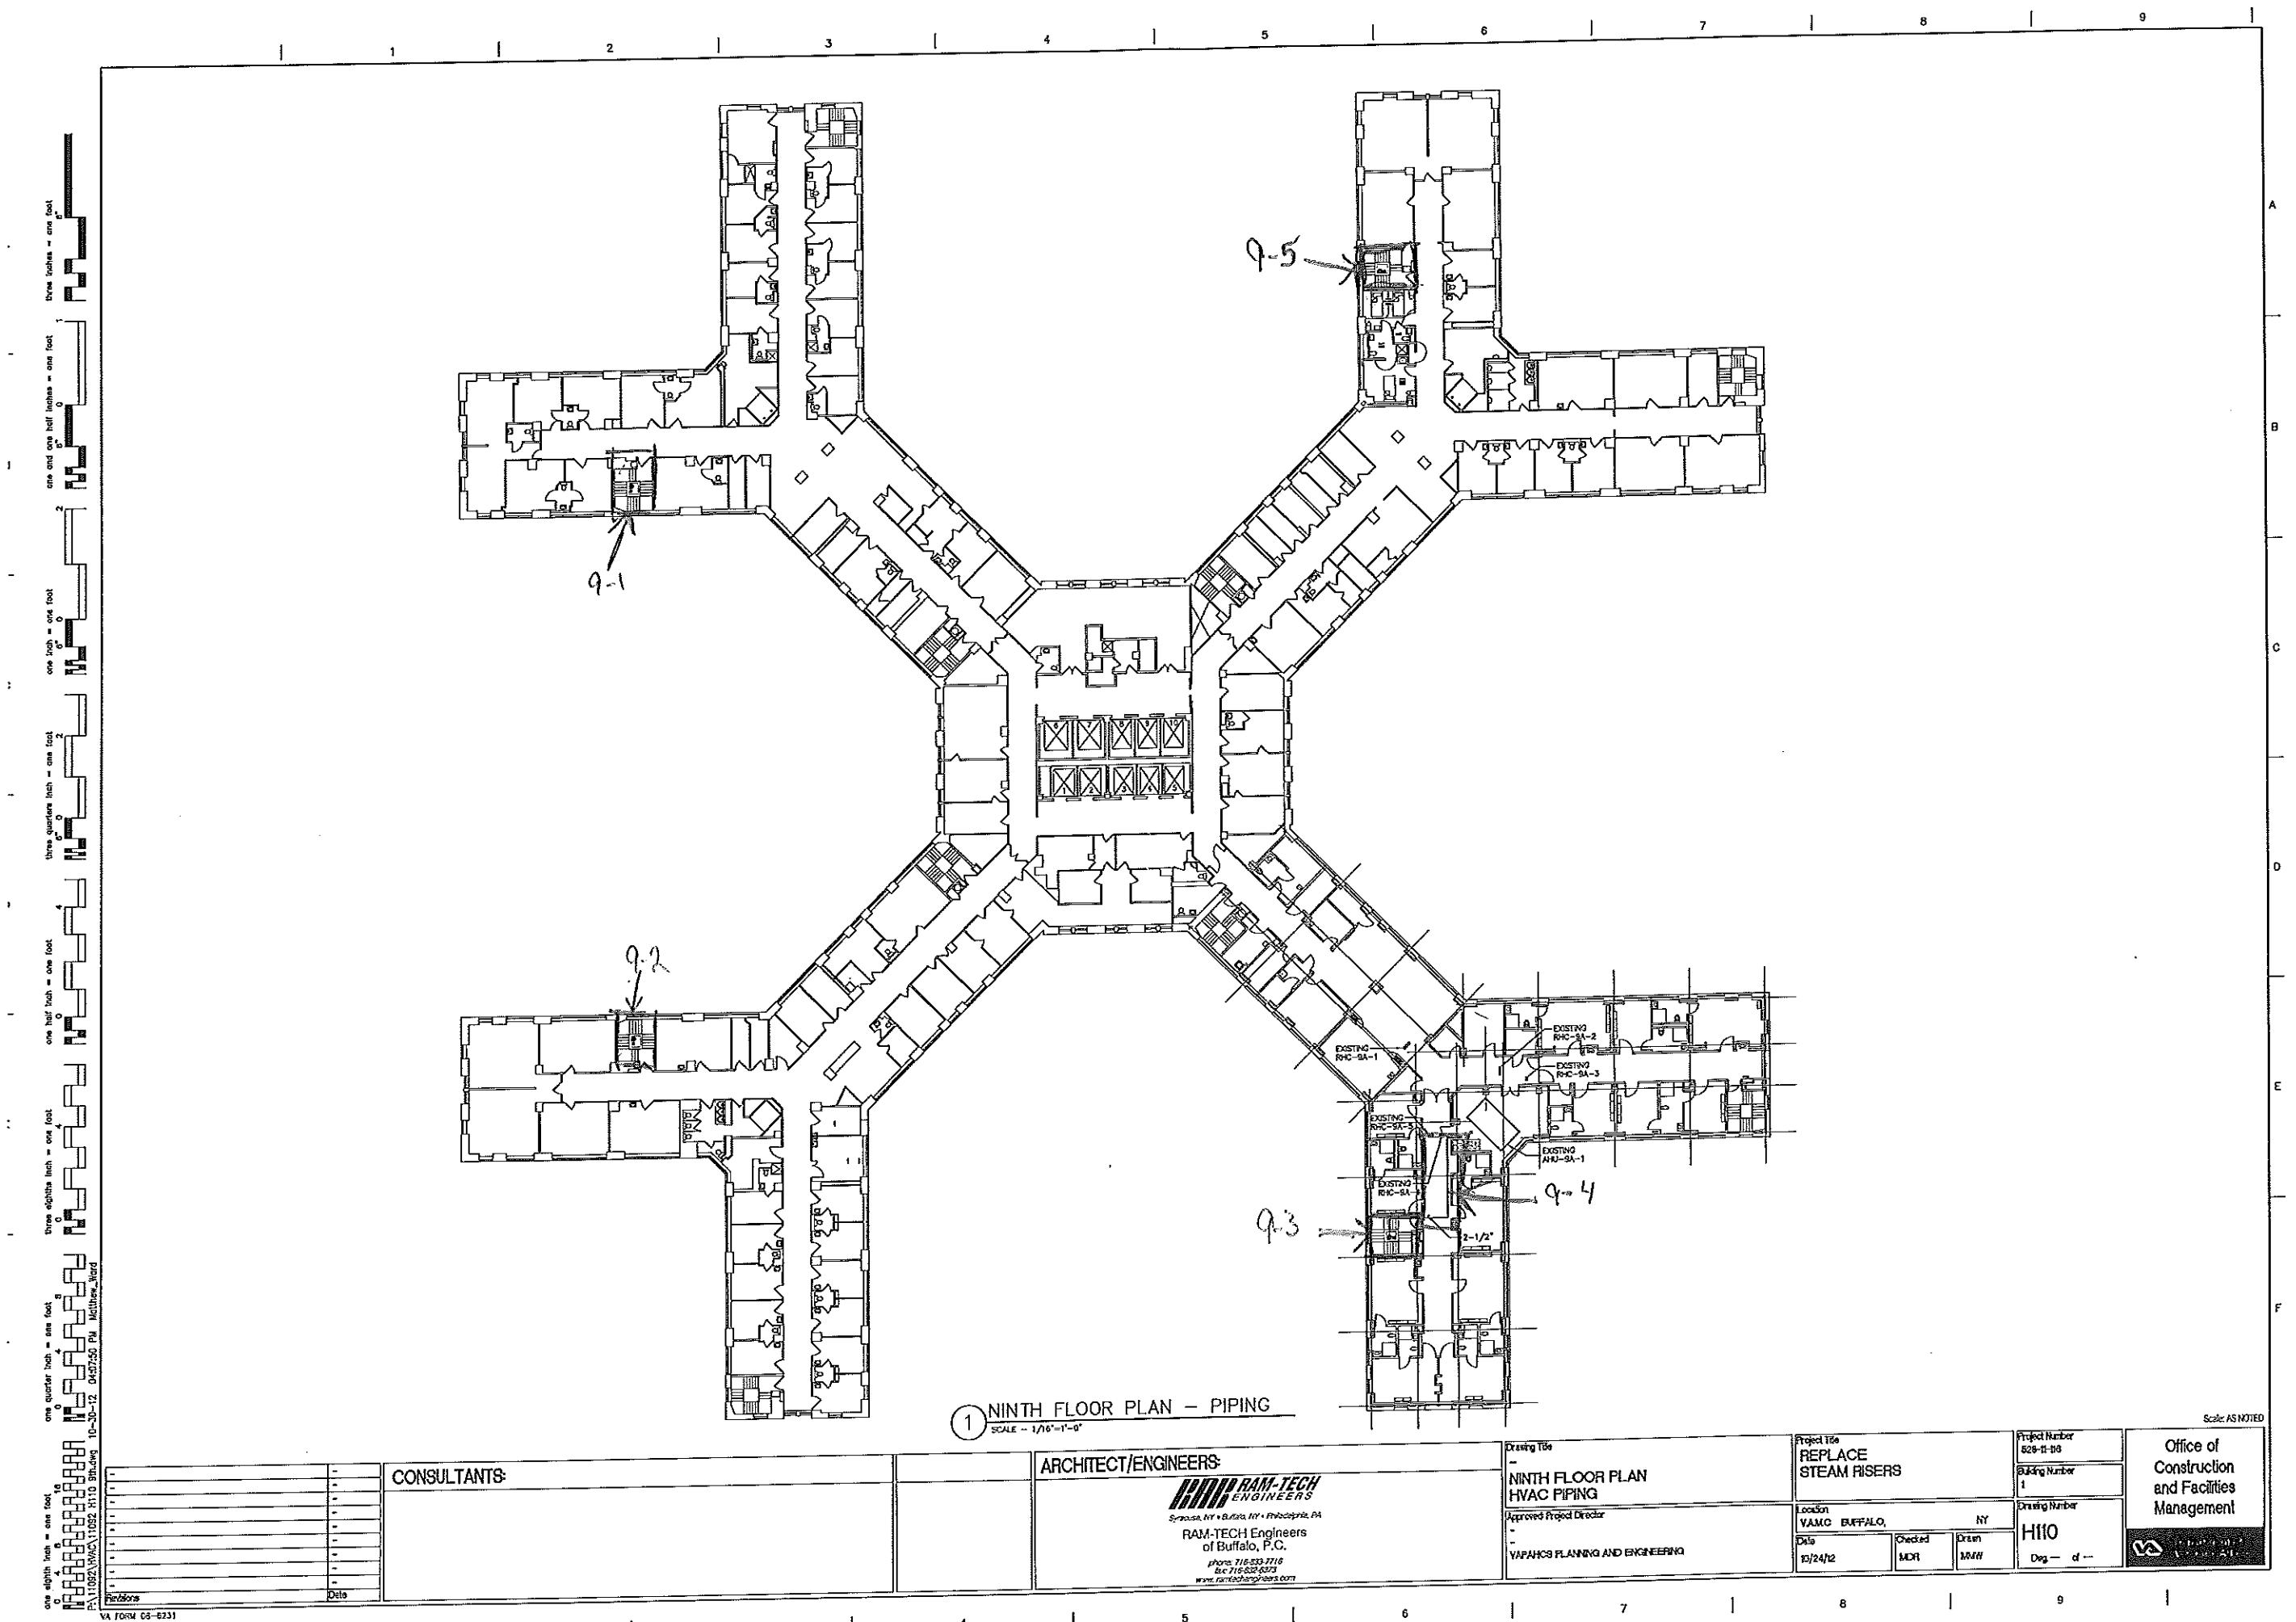

	1	2	3	4	5	6	7	8	9		
one eighth inch = one foot one quarter inch = one foot one half inch = one foot three eighths inch = one foot one quarter inch = one foot one half inch = one foot three quarters inch = one foot one inch = one foot one and one half inches = one foot three inches = one foot 6"										A B C D E F	
<b>1 TENTH FLOOR PLAN - PIPING</b> SCALE - 1/16"=1'-0"											
<b>CONSULTANTS:</b> P.A. 110520 WNC 110520 H111 Parsons			<b>ARCHITECT/ENGINEERS:</b>  RAM-TECH Engineers of Buffalo, P.C. phone 716-633-7716 fax 716-633-5373 <a href="http://www.ramtechengineers.com">www.ramtechengineers.com</a>			<b>Drawing No.</b> TENTH FLOOR PLAN HVAC PIPING Approved Project Director VAPAHCS PLANNING AND ENGINEERING		<b>Project No.</b> REPLACE STEAM RISERS Location VAMC BUFFALO, NY Date 10/24/12 Checked MDR Drawn MMW Dwg -- d --		<b>Office of Construction and Facilities Management</b> 	
VA FORM 08-6231											



## Appendix E Site Photographs

HAN 401- Transite pipe

